PROJECT: STRATFORD HOUSE LIFESTYLE VILLAGE

PLANSET: PRELIMINARY ROADS DRAINAGE DESIGN

CLIENT: COMMON GROUND PROPERTY P/L



LOCALITY PLAN
NOT TO SCALE

LGA: WOLLONDILLY SHIRE COUNCIL

STRATFORD HOUSE PRECINCT, TAHMOOR, NSW LOTS 1-7, 22, 23, 27-32, 35-37 DP 12096 & LOTS 2-3 DP236262

DRAWI	NGS	SLIST
DWG NO.	REV	DWG TITLE
GENERAL		
PS04-A000	С	COVER SHEET
PS04-A010	С	VIEWPORT REFERENCE PLAN
PS04-A050	С	DEVELOPMENT OVERVIEW PLAN
CONSTRU	CTION	MANAGEMENT WORKS
PS04-B300	С	SEDIMENT & EROSION CONTROL PLAN
PS04-B310	Α	SEDIMENT & EROSION CONTROL DETAILS
EARTHW	DRKS	
PS04-C100	С	EARTHWORKS GRADING PLAN - LAYOUT 1
PS04-C101	В	EARTHWORKS GRADING PLAN - LAYOUT 2
PS04-C102	В	EARTHWORKS GRADING PLAN - LAYOUT 3
PS04-C500	С	EARTHWORKS CUT – FILL PLAN
PS04-C600	В	EARTHWORKS SECTION A
ROADWOI	RKS	I
	c	ROADWORKS PLAN - LAYOUT 1
PS04-D101	c	ROADWORKS PLAN - LAYOUT 2
PS04-D102	В	ROADWORKS PLAN - LAYOUT 3
PS04-D200	С	ACCESS ROAD 1 (21-MSC01) LONG. SECTION AND TYPICAL CROSS SECTION
PS04-D201	В	ACCESS ROAD 2 (21-MSC02) LONG. SECTION AND TYPICAL CROSS SECTION
PS04-D203	В	ACCESS ROAD 3 (21-MSC03) LONG. SECTION AND TYPICAL CROSS SECTION
PS04-D205	С	ACCESS ROAD 5 (21-MSC05) LONG. SECTION AND TYPICAL CROSS SECTION (SHEET 1)
PS04-D206	С	ACCESS ROAD 5 (21-MSC05) LONG. SECTION AND TYPICAL CROSS SECTION (SHEET 2)
PS04-D207	В	ACCESS ROAD 6 (21-MSC06) LONG. SECTIONS AND TYPICAL CROSS SECTION
PS04-D208	С	ACCESS ROAD 7 (21-MSC07) & 8 (21-MSC08) LONG. SECTIONS AND TYPICAL CROSS SECTION
PS04-D209	В	ACCESS ROAD 9 (21-MSC09) & 10 (21-MSC10) LONG. SECTIONS AND TYPICAL CROSS SECTION
PS04-D210	В	ACCESS ROAD 12 (21-MSC12) LONG. SECTION AND TYPICAL CROSS SECTION
PS04-D211	В	ACCESS ROAD 13 (21-MSC13) & 14 (21-MSC14) LONG. SECTIONS AND TYPICAL CROSS SECTIONS
PS04-D212	В	ACCESS ROAD 15 (21-MSC15) LONG. SECTION AND TYPICAL CROSS SECTION
PS04-D213	В	ACCESS LANE 1 (21-MSL01) & 2 (21-MSL02) LONG. SECTIONS AND TYPICAL CROSS SECTION
PS04-D214	В	ACCESS LANE 3 (21-MSL03) & 4 (21-MSL04) LONG. SECTIONS AND TYPICAL CROSS SECTION
PS04-D215	В	ACCESS LANE 7 (21-MSL07) LONG. SECTION AND TYPICAL CROSS SECTION
DRAINAG	E WO	RKS
PS04-E100	C	DRAINAGE PLAN - LAYOUT 1
PS04-E101	C	DRAINAGE PLAN - LAYOUT 2
PS04-E102	С	DRAINAGE PLAN - LAYOUT 3
PS04-E200	В	TYPICAL DRAINAGE DETAILS
PS04-E600	С	OSD CATCHMENT PLAN, MODEL AND RESULTS
PS04-E700	С	WATER QUALITY CATCHMENT PLAN, MODEL AND RESULTS
FINAL CIV	IL WO	DRKS
PS04-G300	В	ACCESS FOOTPATH PLAN
PS04-G310	В	ACCESS FOOTPATH 1 (21-MSP01) LONGITUDINAL SECTION
PS04-G311	В	ACCESS FOOTPATH 2 (21-MSP02) & 3 (21-MSP03) LONG. SECTIONS

GENERAL NOTES

7. ALL BATTERS TO BE MAXIMUM 1V:4H.

1. THIS PLAN IS FOR DEVELOPMENT APPLICATION PURPOSE AND NOT FOR CONSTRUCTION. DESIGN
TO BE REVIEWED AND UPDATED FOR CONSTRUCTION CERTIFICATE.

2. ALL WORK TO BE CARRIED OUT IN ACCORDANCE WITH, AND THESE NOTES ARE TO BE READ IN CONJUNCTION WITH THE RELEVANT AUSTRALIAN STANDARDS, COUNCIL SPECIFICATIONS, AND ALL PROJECT CONSULTANT'S PLANS AND REPORTS.

3. INTERNAL SURVEY INFORMATION SHOWN BASED ON DATA PROVIDED BY AUSTRALIAN SURVEYS SOLUTION.

4. LEVELS ARE TO AUSTRALIAN HEIGHT DATUM (AHD).5. EXISTING SURFACE CONTOURS BASED ON SURVEY AND LIDAR SURFACES.6. FINAL SURFACE CONTOURS ARE BASED ON PROPOSED AND EXISTING SURFACE.

DEVELOPMENT APPLICATION - NOT FOR CONSTRUCTION

REV DESCRIPTION PROJECT MANAGER | CLIENT AMENDMENTS TO ADDRESS MINOR LAYOUT CHANGE AND COUNCIL RF 31/07/2020 RK |CG/AVG| SA COMMON GROUND PROPERTY P/L B AMENDED AS PER UPDATED DESIGN RK CG/AVG JF A INITIAL RELEASE PROJECT NAME/PLANSET TITLE 20/11/2019 GM | CG/AVG | SA DISCLAIMER & COPYRIGHT This plan must not be used for construction unless signed as approved by STRATFORD HOUSE LIFESTYLE VILLAGE principal certifying authority. All measurements in millimetres unless otherwise specified. PRELIMINARY ROADS DRAINAGE DESIGN This drawing must not be reproduced in whole or part without prior written consent of Martens & Associates Pty Ltd. STRATFORD HOUSE PRECINCT, TAHMOOR, NSW (C) Copyright Martens & Associates Pty Ltd LOTS 1-7, 22, 23, 27-32, 35-37 DP 12096 & LOTS 2-3 DP236262

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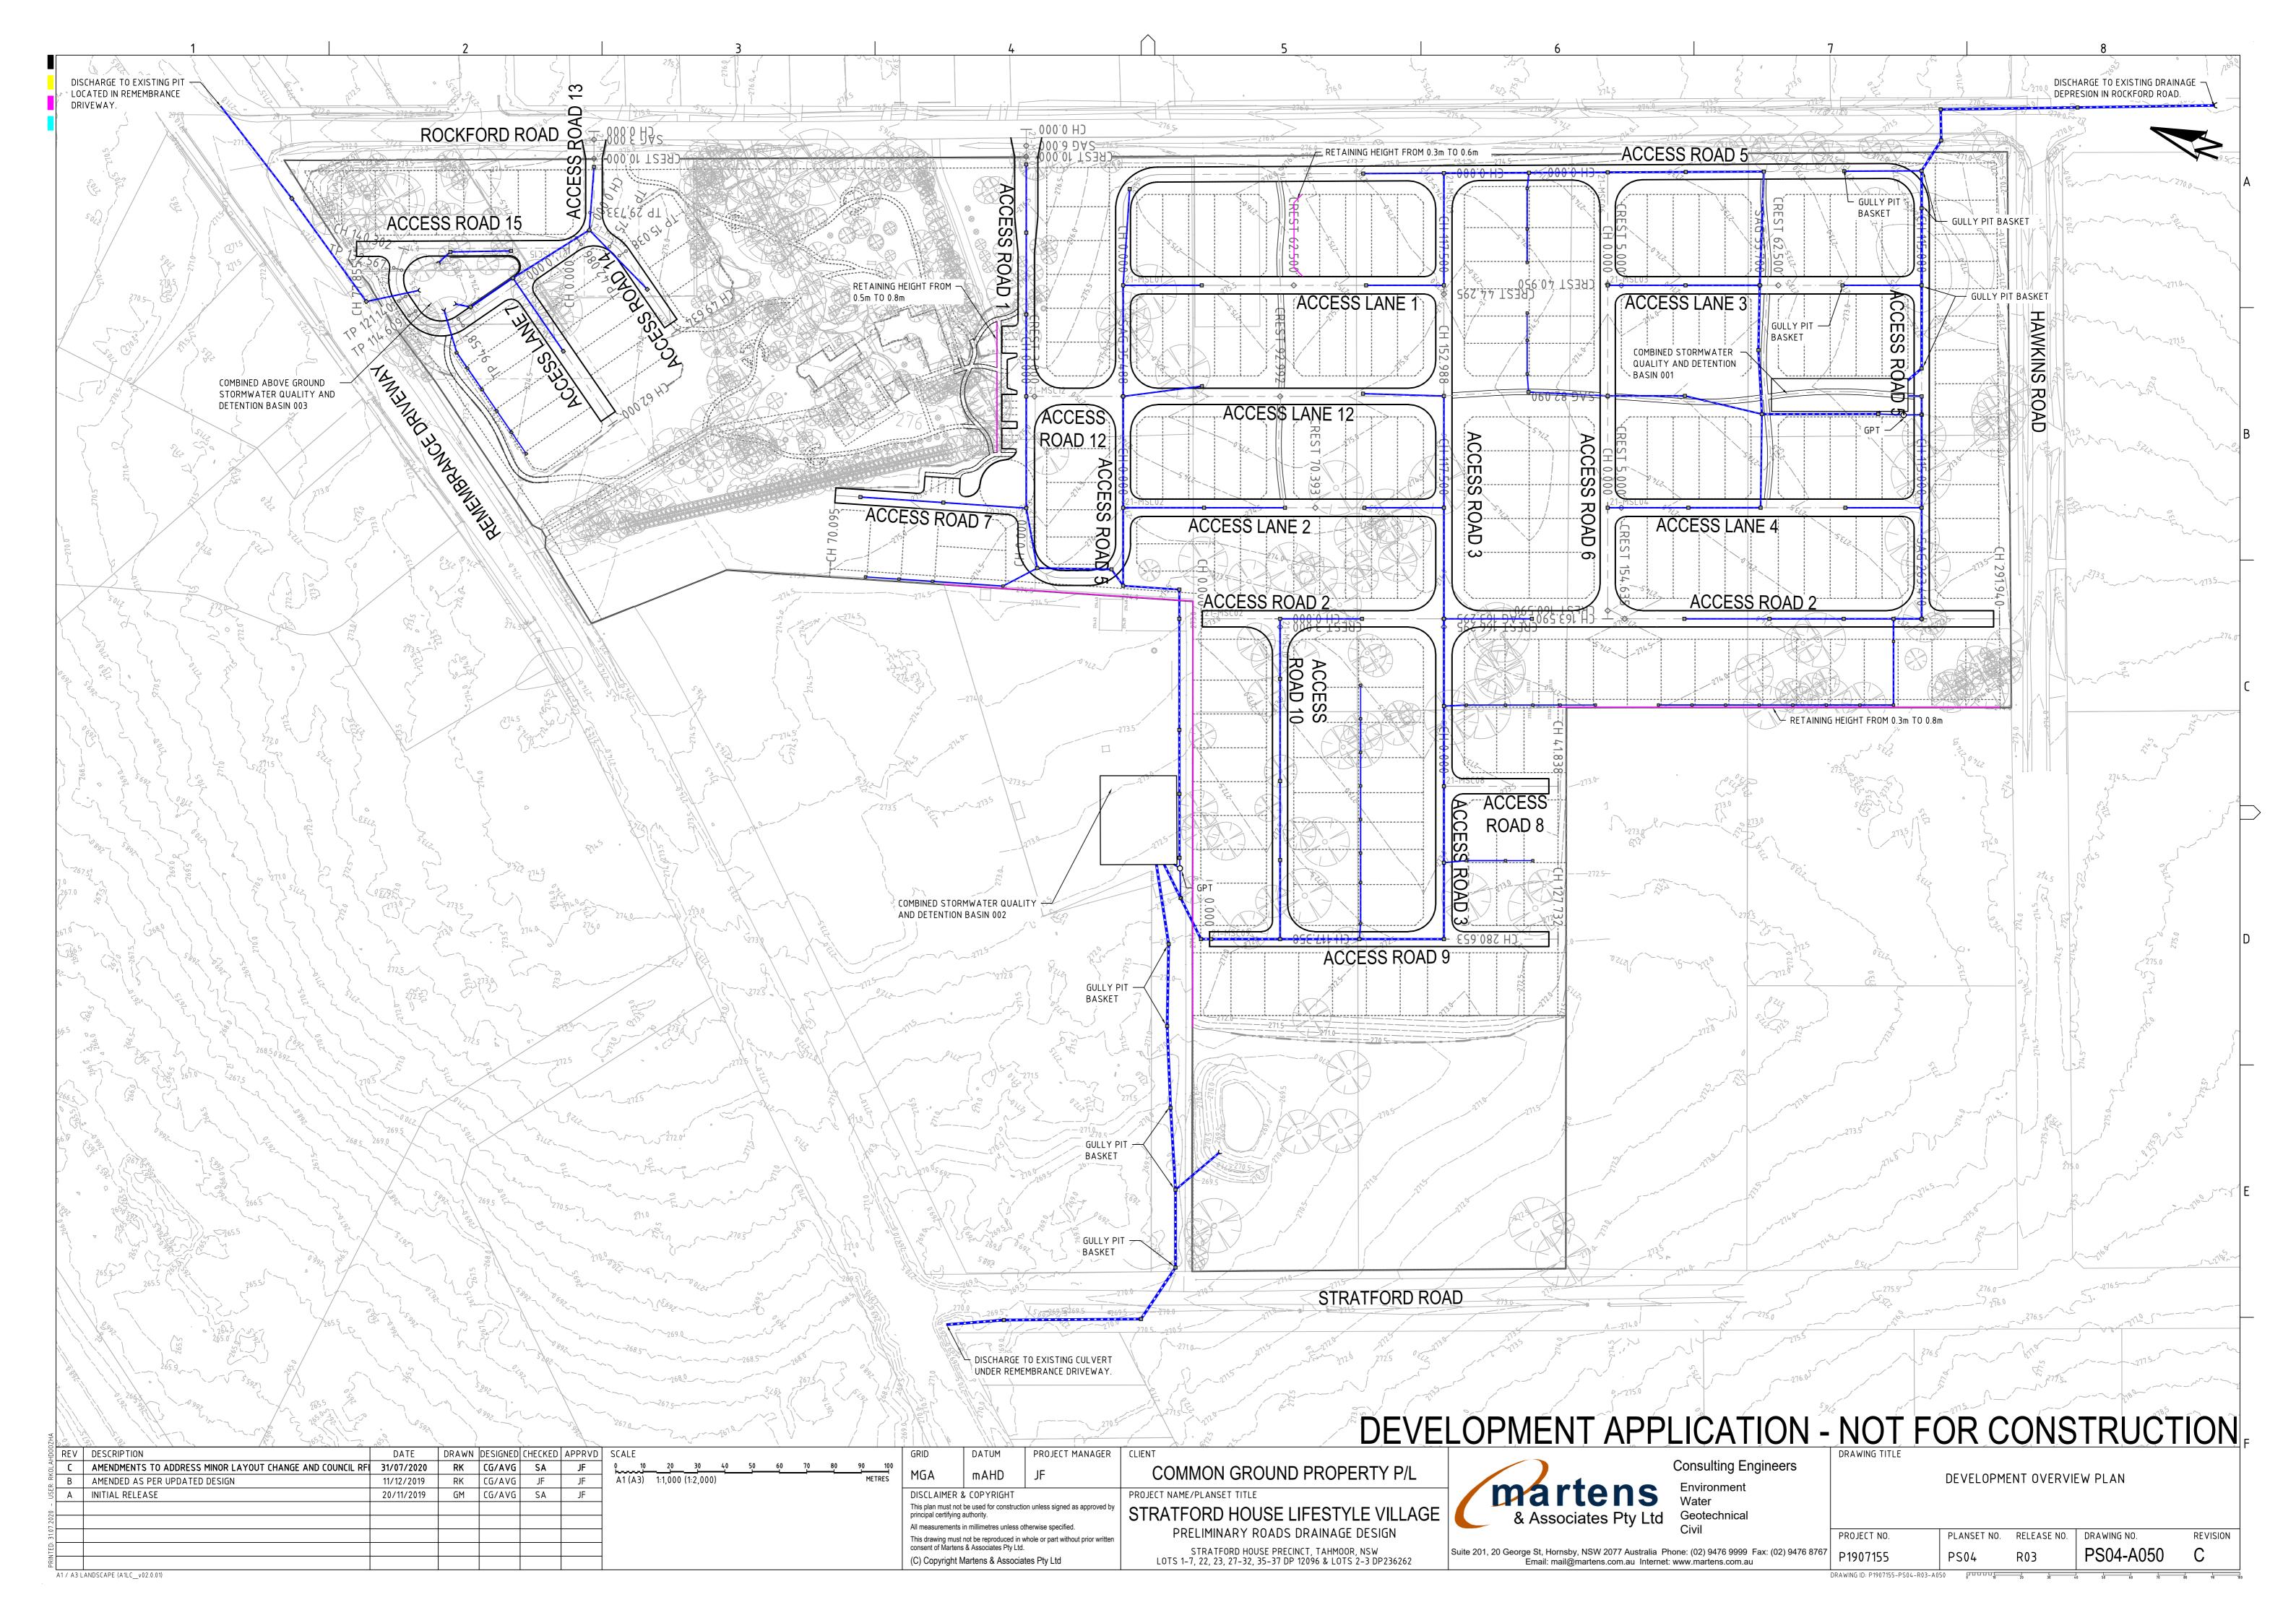
Consulting Engineers


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Water
Geotechnical
Civil


 COVER SHEET

 PROJECT NO.
 PLANSET NO.
 RELEASE NO.
 DRAWING NO.
 REVISION

 P1907155
 PS04
 R03
 PS04-A000
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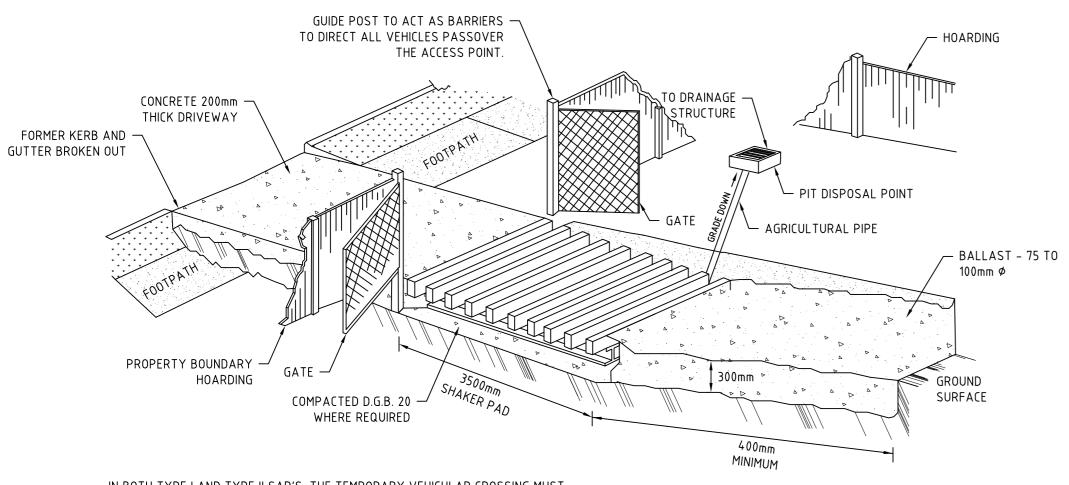


STABILISED ACCESS POINT

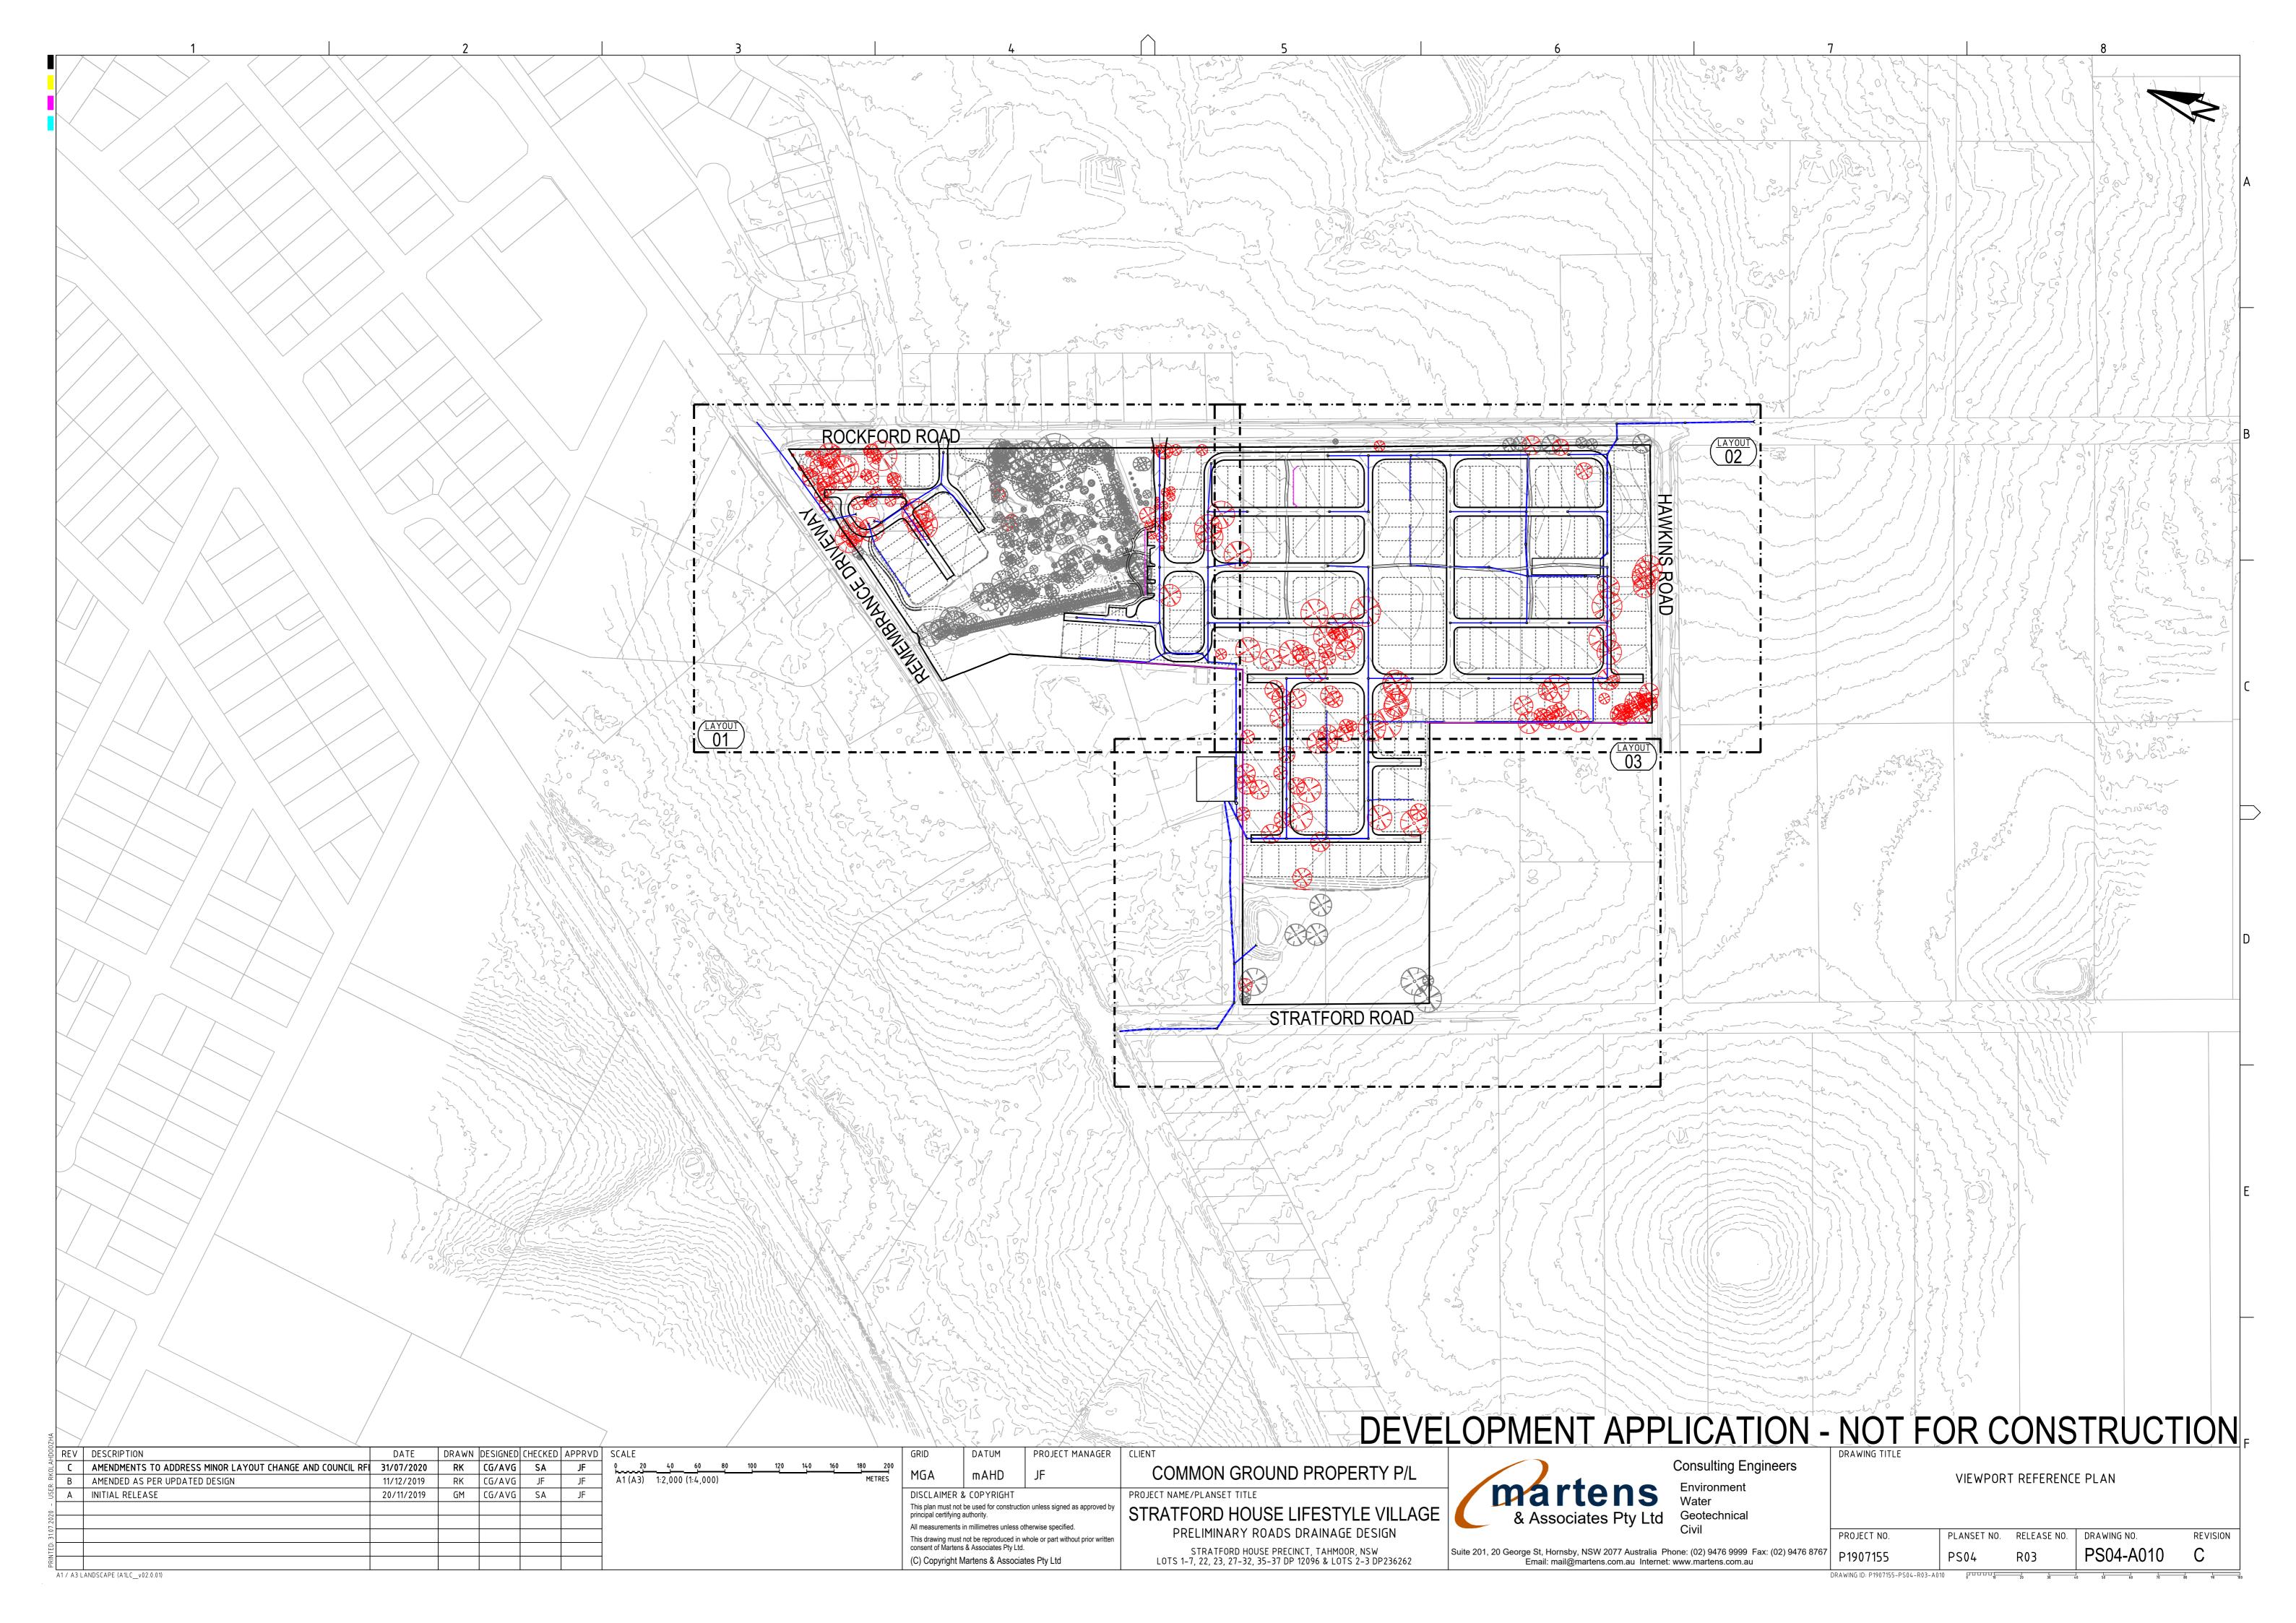TYPE II SAP

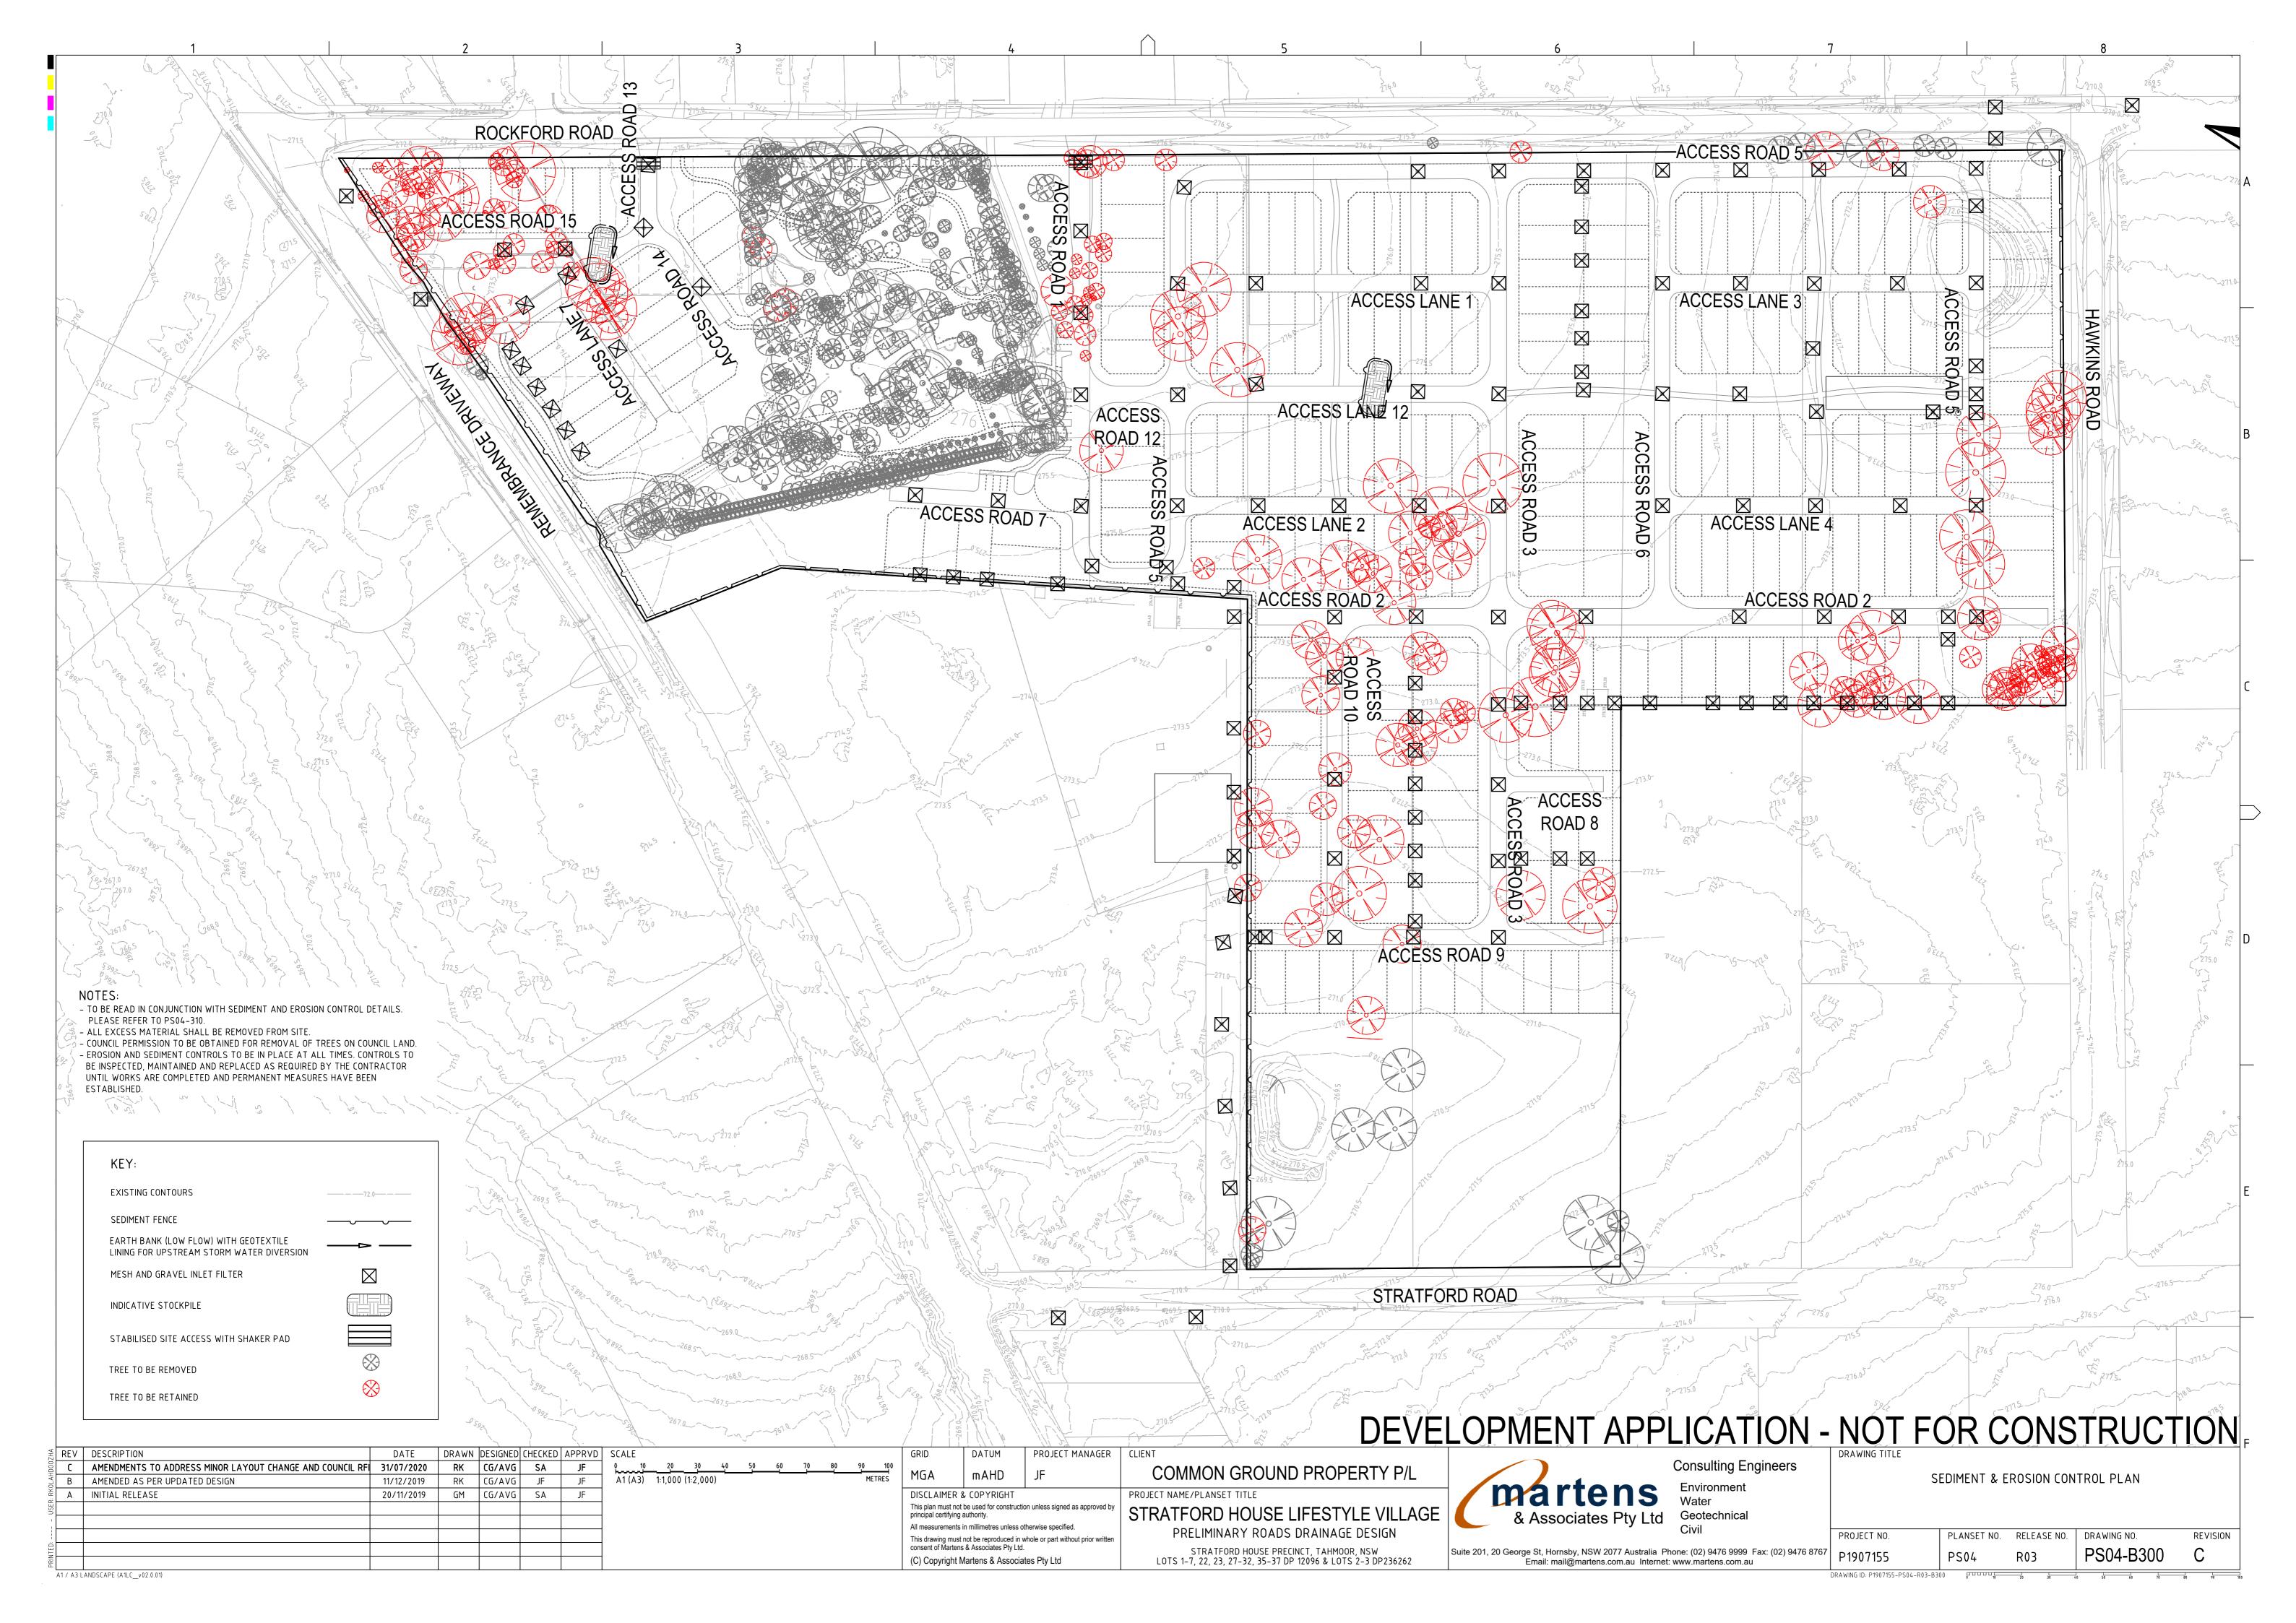THE TYPE II SAP DESIGN IS MORE DEFINED IN THAT IT REQUIRES AN AREA OF BALLAST WITHIN THE SITE COMBINED WITH A SHAKER PAD; ADJACENT THE SHAKER PAD AND IN THE PUBLIC WAY IS A TEMPORARY (CONCRETE) VEHICULAR CROSSING. (SEE DIAGRAM)

STABILISED ACCESS POINT - TYPE 2



IN BOTH TYPE I AND TYPE II SAP'S, THE TEMPORARY VEHICULAR CROSSING MUST:

- CONNECT TO AN EXISTING GUTTER LAYBACK (WHERE THE KERB AND GUTTER EXIST) . IF A GUTTER LAYBACK DOES NOT EXIST THEN THE
- CONNECTION MUST BE MADE TO THE GUTTER BY REMOVING THE ADJCENT KERB SECTION ONLY.
- CONNECT TO A DISH CROSSING (WHERE KERB AND GUTTER DOES NOT EXIST). IF A DISH CROSSING DOES NOT EXIST, THEN IT MUST BE CONSTRUCTED IN ACCORDANCE WITH DETAILS CONTAINED IN COUNCIL'S ISSUED FOOTPATH CROSSING LEVELS.

IT SHOULD BE NOTED THAT THESE TYPES OF SAPS ARE CONSIDERED TO BE APPLICABLE FOR THE MAJORITY OF ACTIVITIES HOWEVER SOME SITES MAY REQUIRE SPECIAL CONSIDERATION.

SHAKER PAD (CATTLE GRID)


A CORRECTLY DESIGNED AND INSTALLED SHAKER PAD WILL ASSIST IN PREVENTING SEDIMENT TRANSFERE FROM A SITE. ANY STABILISED ACCESS POINT (SAP) CAN BE DESIGNED WITH A SHAKER PAD (COMPULSOPRY IN TYPE II SAP'S)


SHAKER PADS CAN BE DESIGNED AND CONSTRUCTED TO ENABLE RE-USE ON FUTURE PROJECTS.

THE SHAKER PAD:

- MUST BE DESIGNED AND CERTIFIED BY A PRACTICING STRUCTURAL ENGINEER. THE CERTIFIED DESIGN SHOULD BE SUBMITTED WITH THE RELEVENT
- CAN BE CONSTRUCTED FROM ANY SUITABLE MATERIAL.
- MUST BE LOCATED ON A SUITABLY PREPARED AND COMPACTED SUB-GRADE/BASE MATERIAL.
- MUST BE SITUATED SUCH THAT THE RUNGS OF THE SHAKER PAD ARE LEVEL WITH THE ADJOINING NATURAL SURFACE.
- MUST BE A MINIMUM OF 3.5m IN LENGTH.
- MUST BE A MINIMUN OF 3.5m IN WIDTH.
- MUST HAVE CLEAR SPACING BETWEEN RUNGS OF 200 250mm.
- RUNGS MUST HAVE A MAXIMUM WIDTH (BEARING AREA) OF 75mm.
- MUST HAVE A MINIMUM CLEAR DEPTH OF 300mm IE FORM THE ROP OF THE RUNG TO THE FINISHED SUB-GRADE/BASE LEVEL.

THE SHAKER PAD MUST BE PROVIDED WITH SUITABLE BARRIERS AT THE SIDES TO ENSURE THAT ALL TYERS OF VEHICLES LEAVING THE SITE TRAVERSE THE DEVICE.

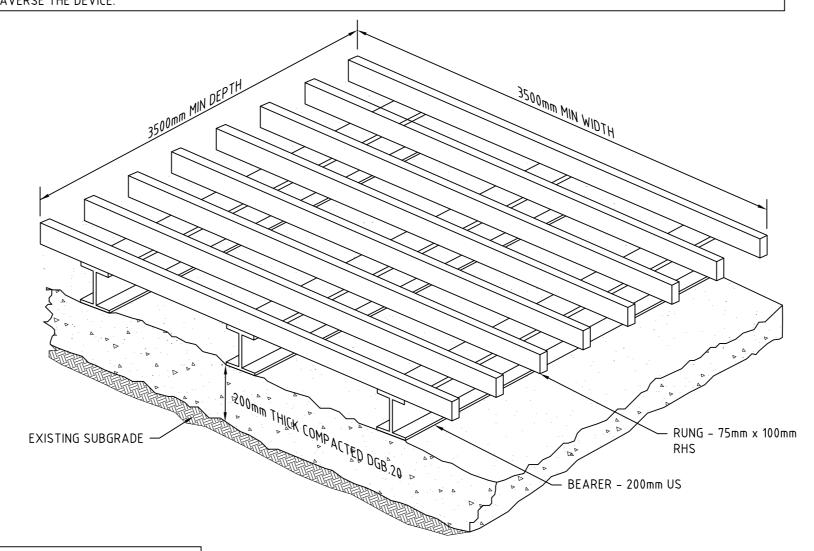


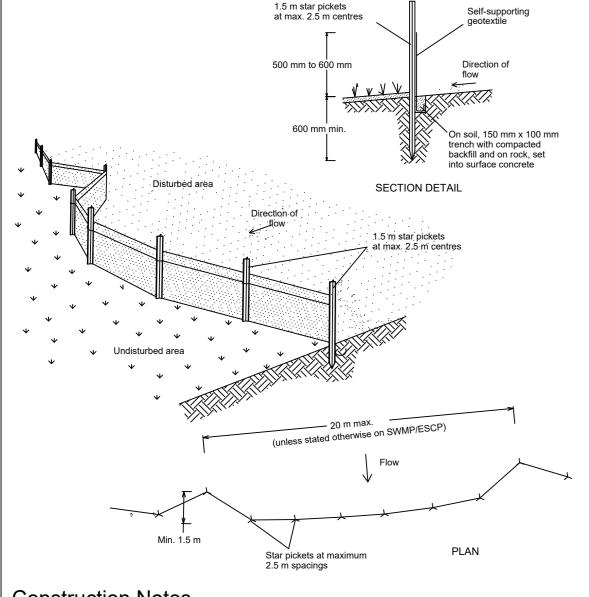

Construction Notes


- 1. Construct sediment fences as close as possible to being parallel to the contours of the site, but with small returns as shown in the drawing to limit the catchment area of any one section.
- The catchment area should be small enough to limit water flow if concentrated at one point to 50 litres per second in the design storm event, usually the 10-year event. 2. Cut a 150-mm deep trench along the upslope line of the fence for the bottom of the fabric to
- be entrenched. 3. Drive 1.5 metre long star pickets into ground at 2.5 metre intervals (max) at the downslope
- edge of the trench. Ensure any star pickets are fitted with safety caps. 4. Fix self-supporting geotextile to the upslope side of the posts ensuring it goes to the base of the trench. Fix the geotextile with wire ties or as recommended by the manufacturer. Only use geotextile specifically produced for sediment fencing. The use of shade cloth for this
- purpose is not satisfactory. 5. Join sections of fabric at a support post with a 150-mm overlap.
- 6. Backfill the trench over the base of the fabric and compact it thoroughly over the geotextile.


SEDIMENT FENCE

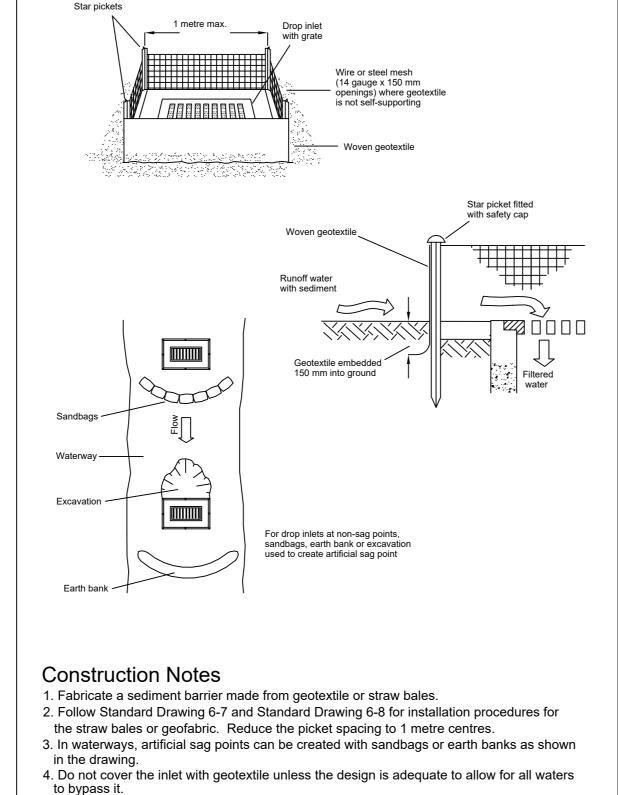

GEOTEXTILE INLET FILTER

SD 6-12

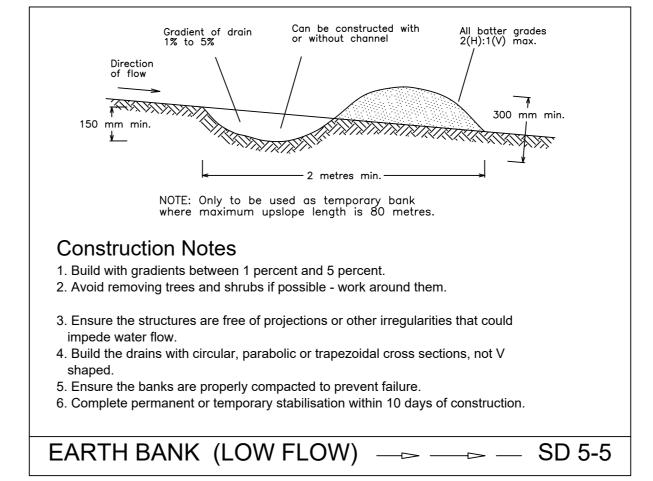

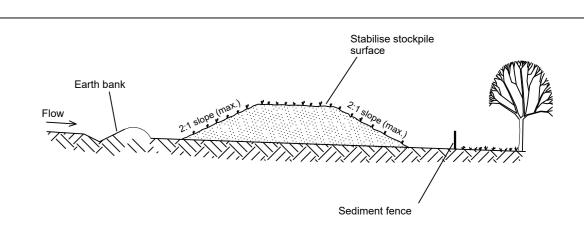


Construction Notes


- 1. Place stockpiles more than 2 (preferably 5) metres from existing vegetation, concentrated
- water flow, roads and hazard areas.
- 2. Construct on the contour as low, flat, elongated mounds. 3. Where there is sufficient area, topsoil stockpiles shall be less than 2 metres in height.
- 4. Where they are to be in place for more than 10 days, stabilise following the approved
- ESCP or SWMP to reduce the C-factor to less than 0.10. 5. Construct earth banks (Standard Drawing 5-5) on the upslope side to divert water around stockpiles and sediment fences (Standard Drawing 6-8) 1 to 2 metres downslope.


STOCKPILES


DEVELOPMENT APPLICATION - NOT FOR CONSTRUCTION


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SECTION A SCALE: HORIZONTAL - 1:100 VERTICAL - 1:100
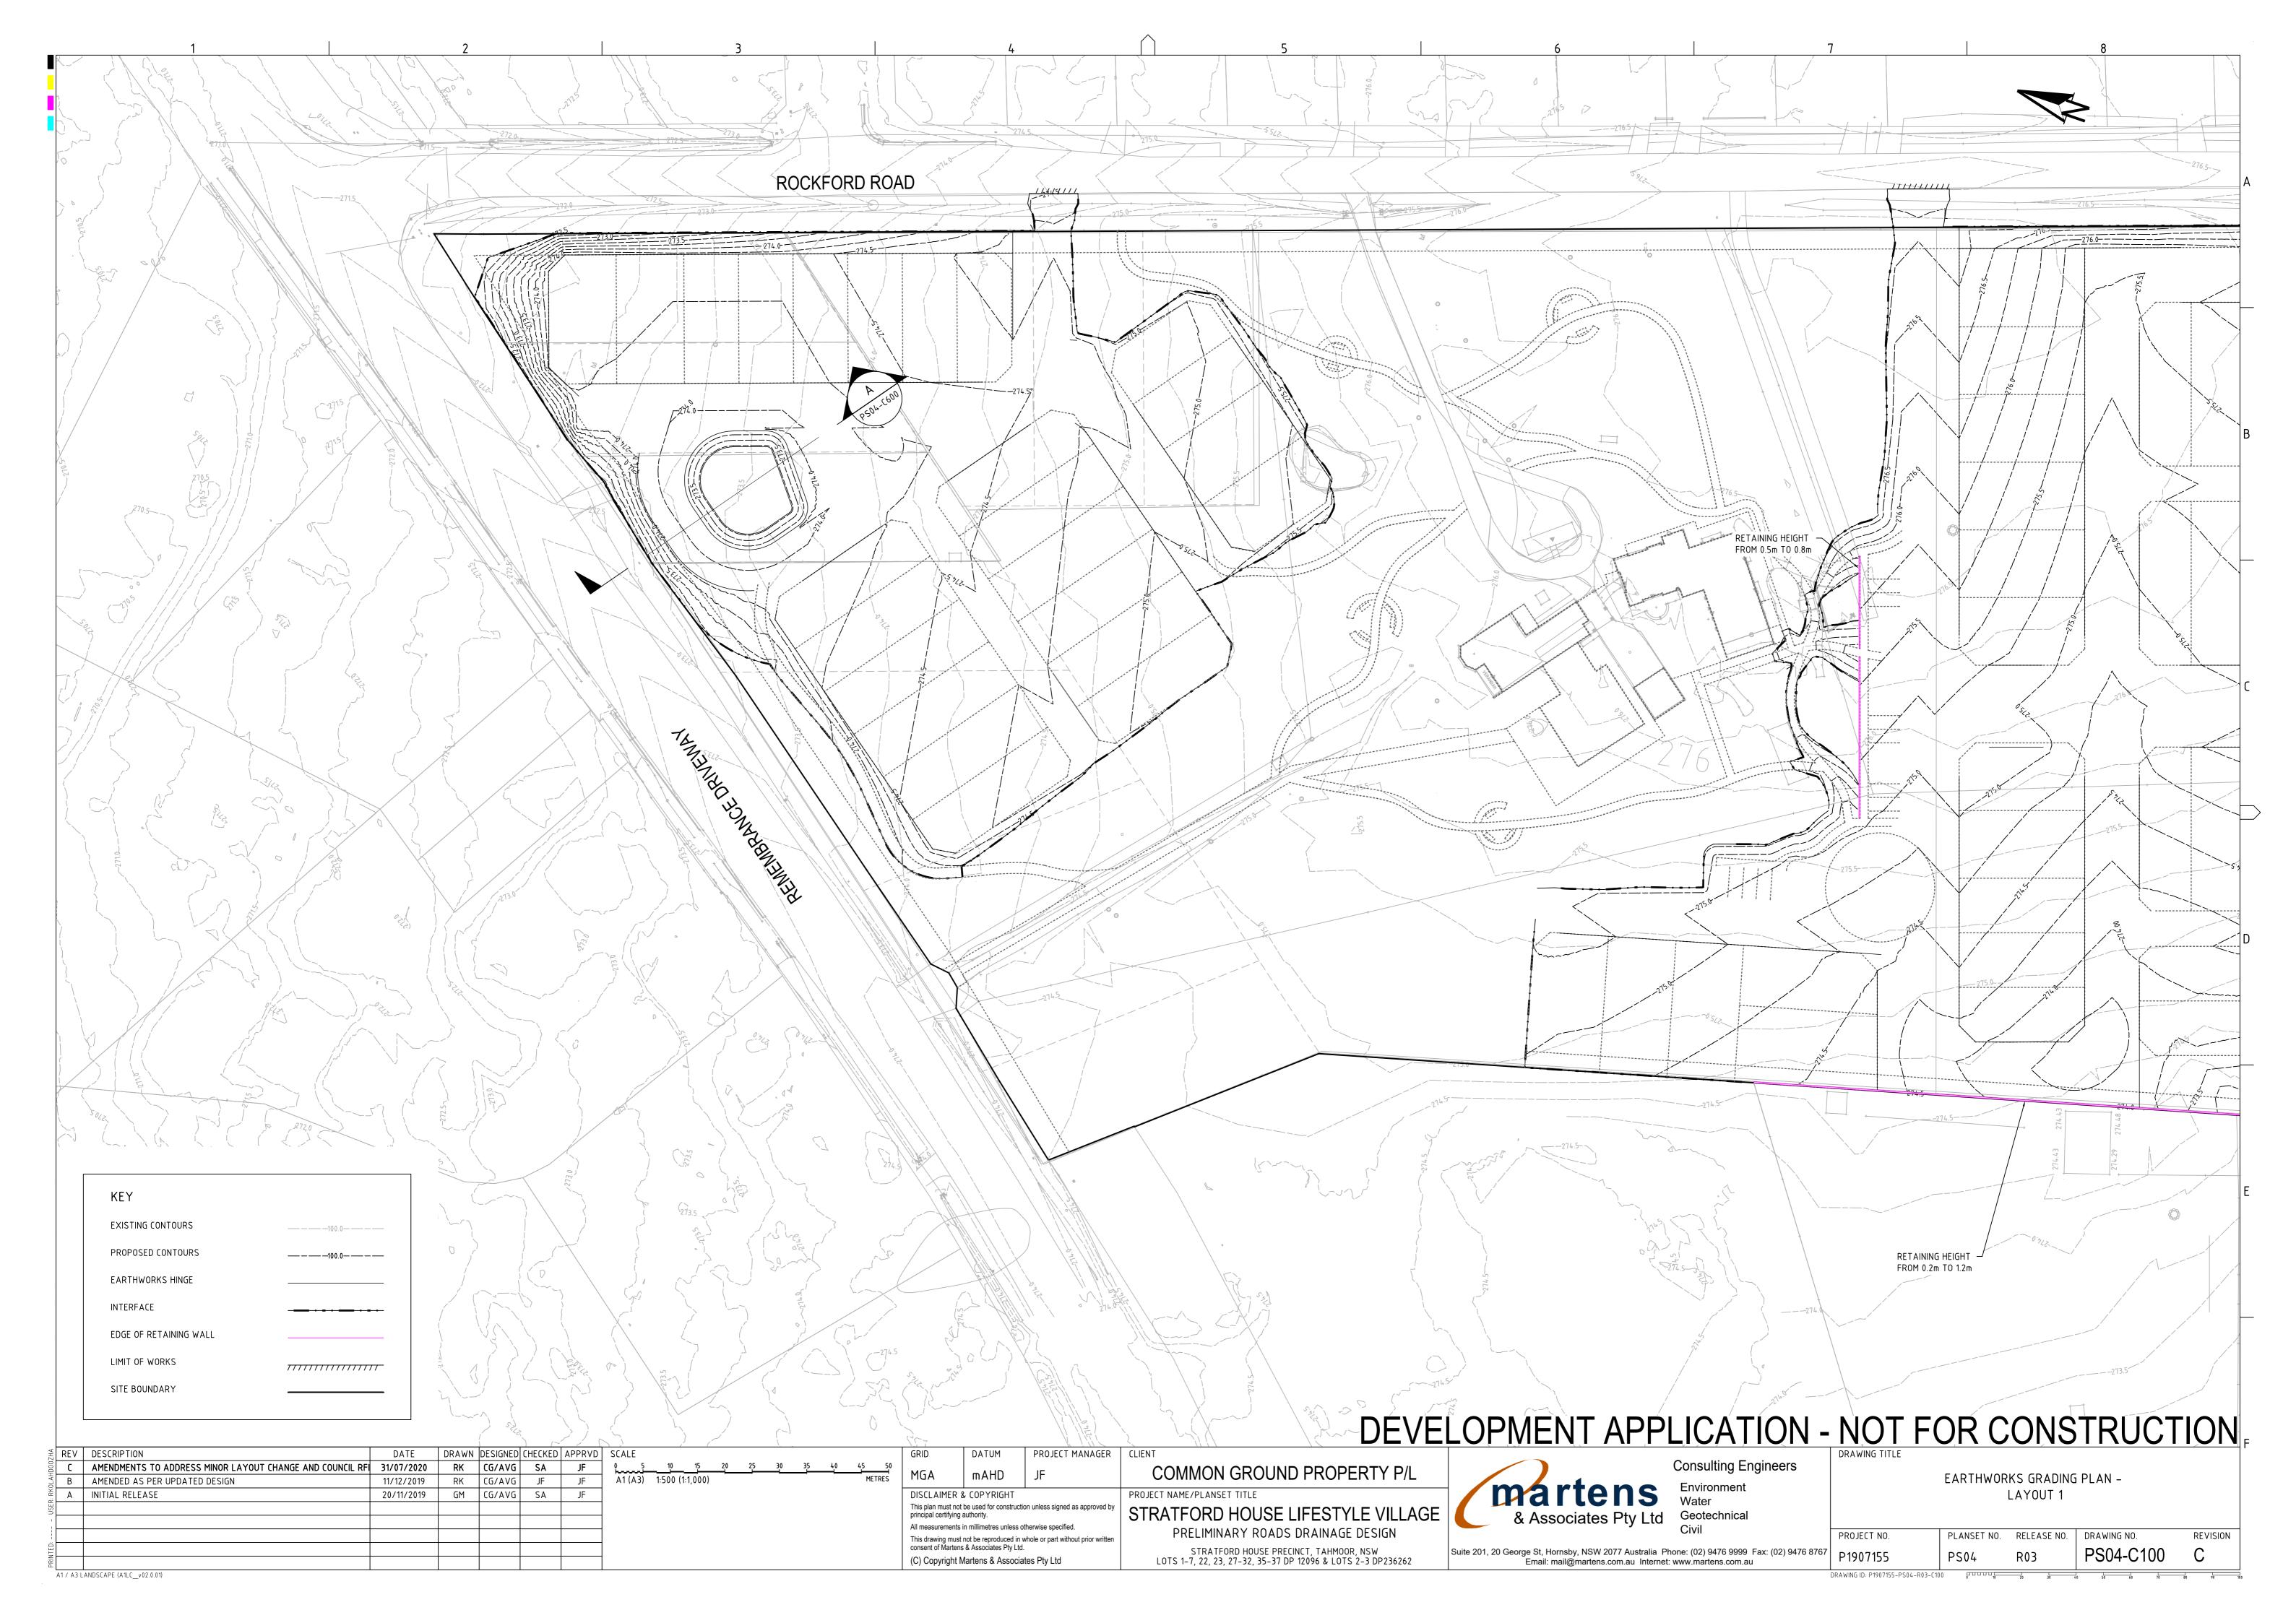
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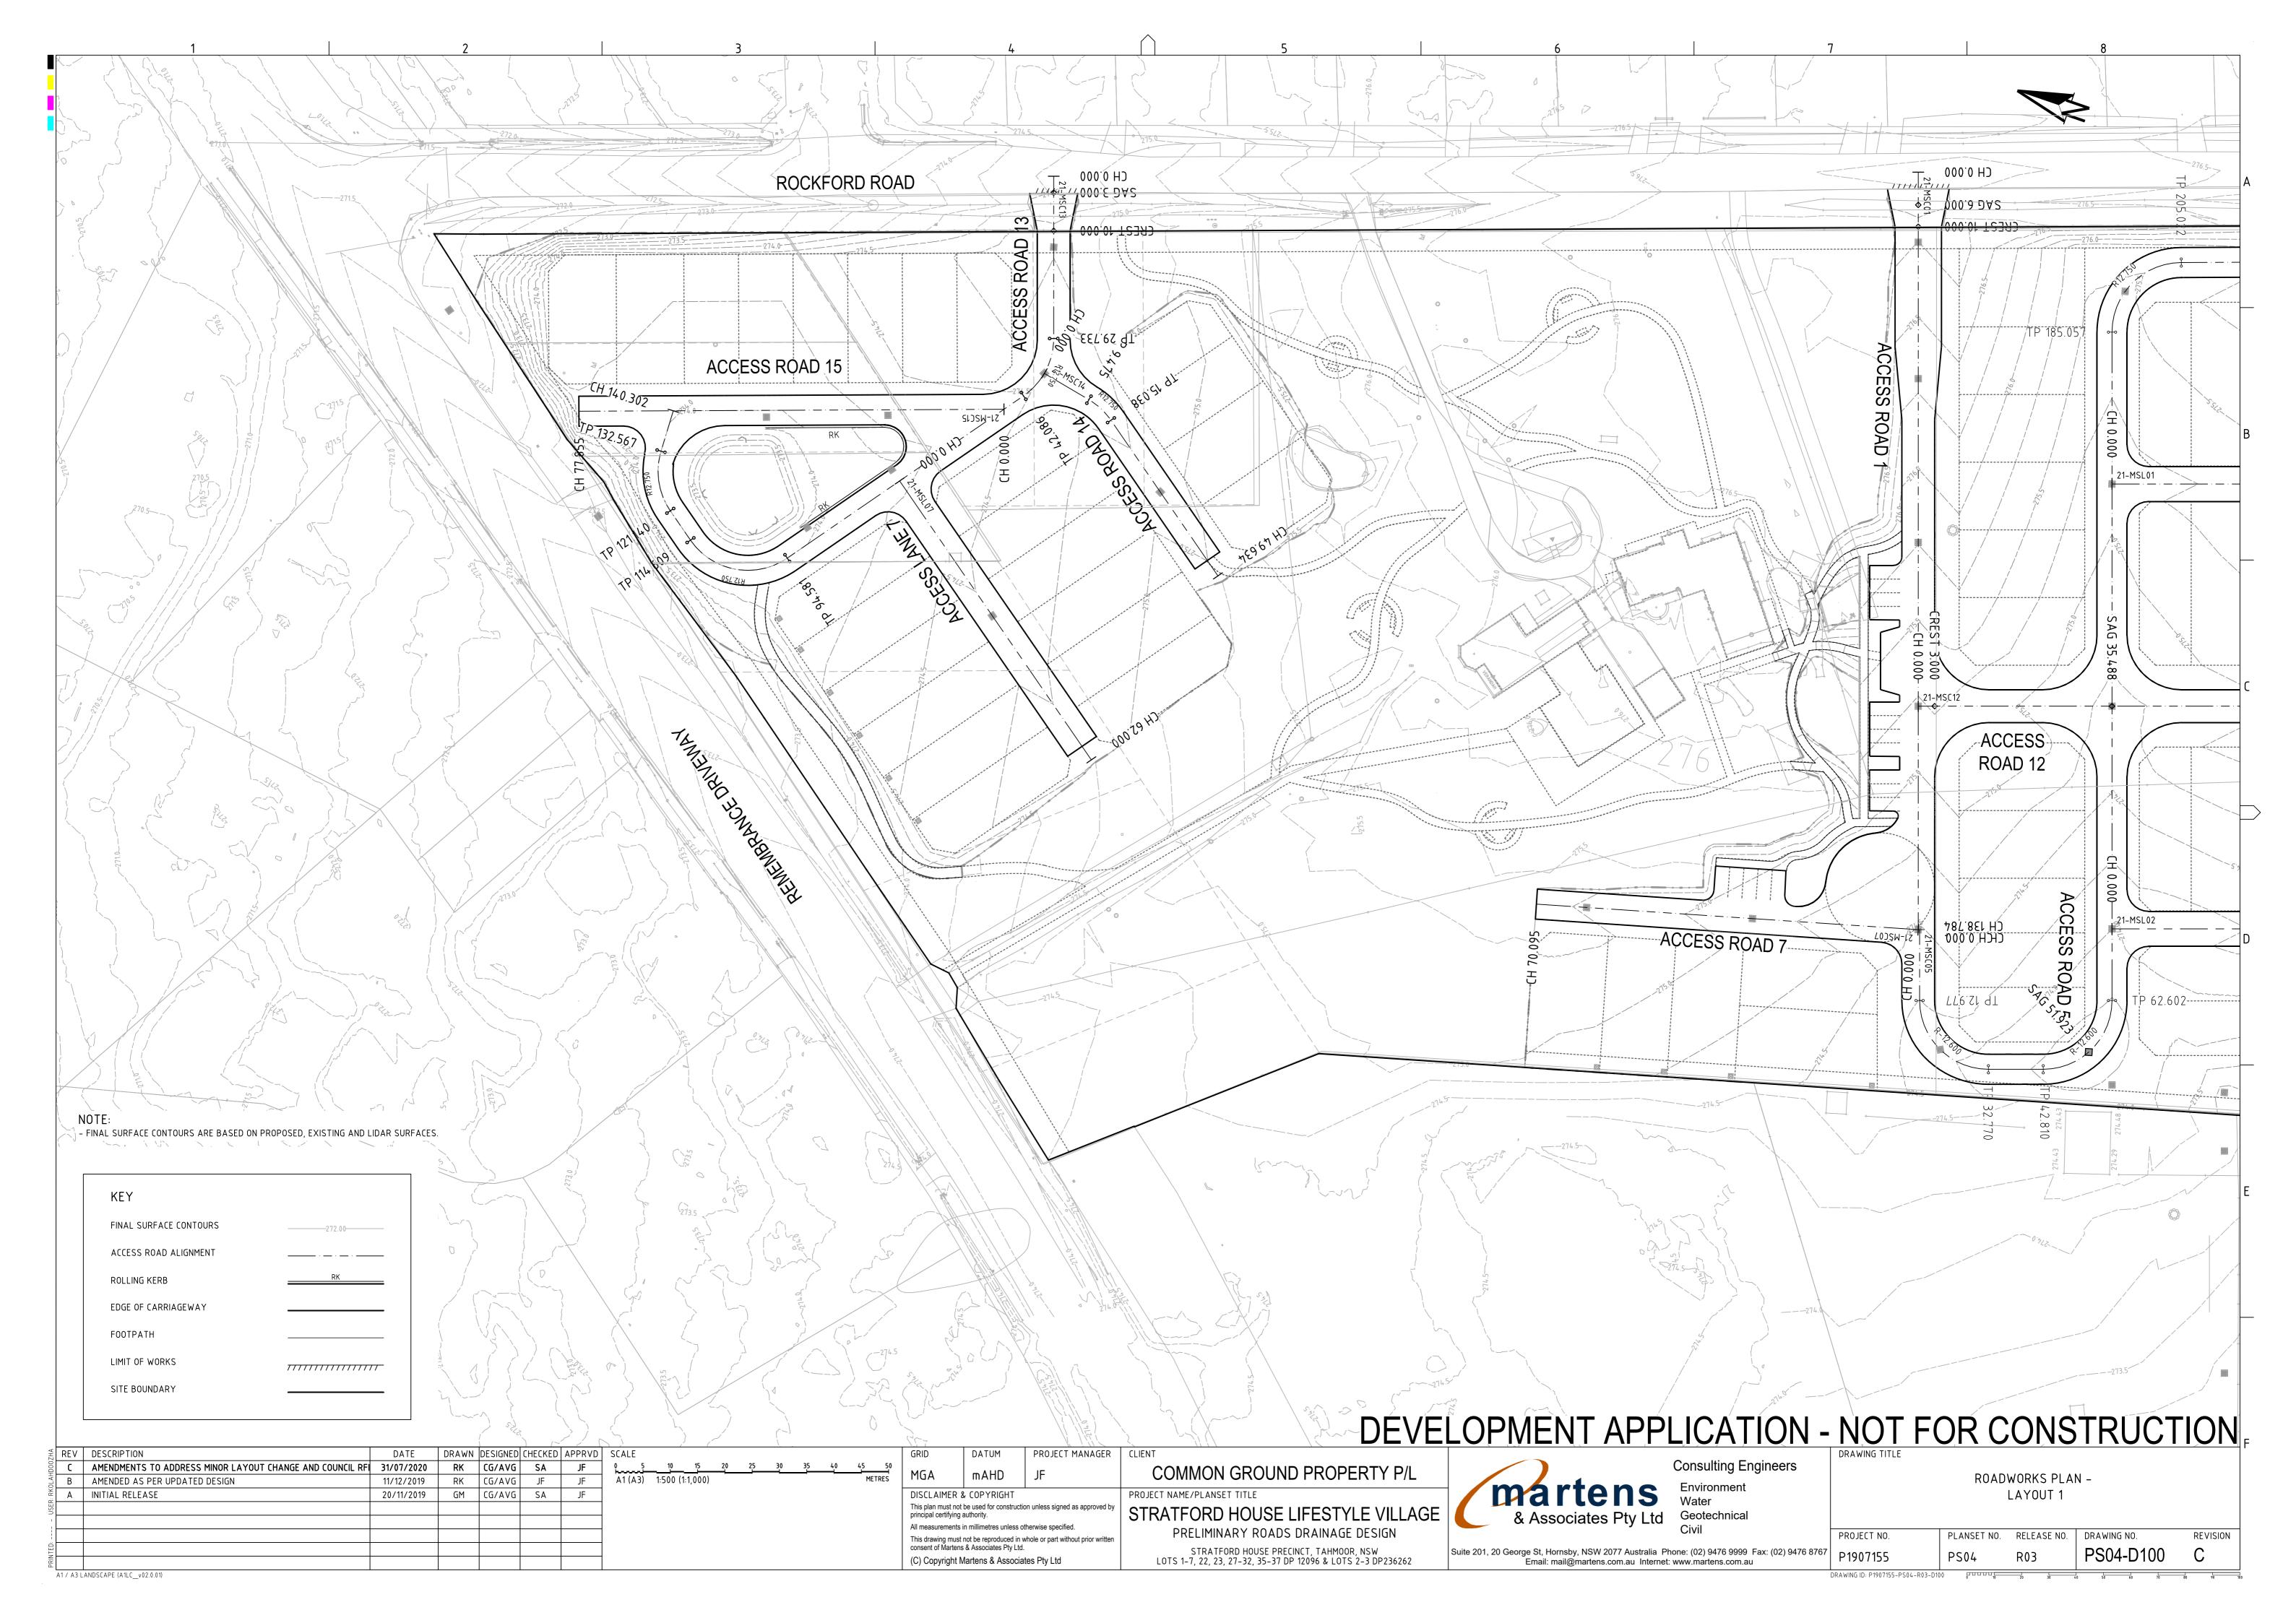
Consulting Engineers Environment Geotechnical

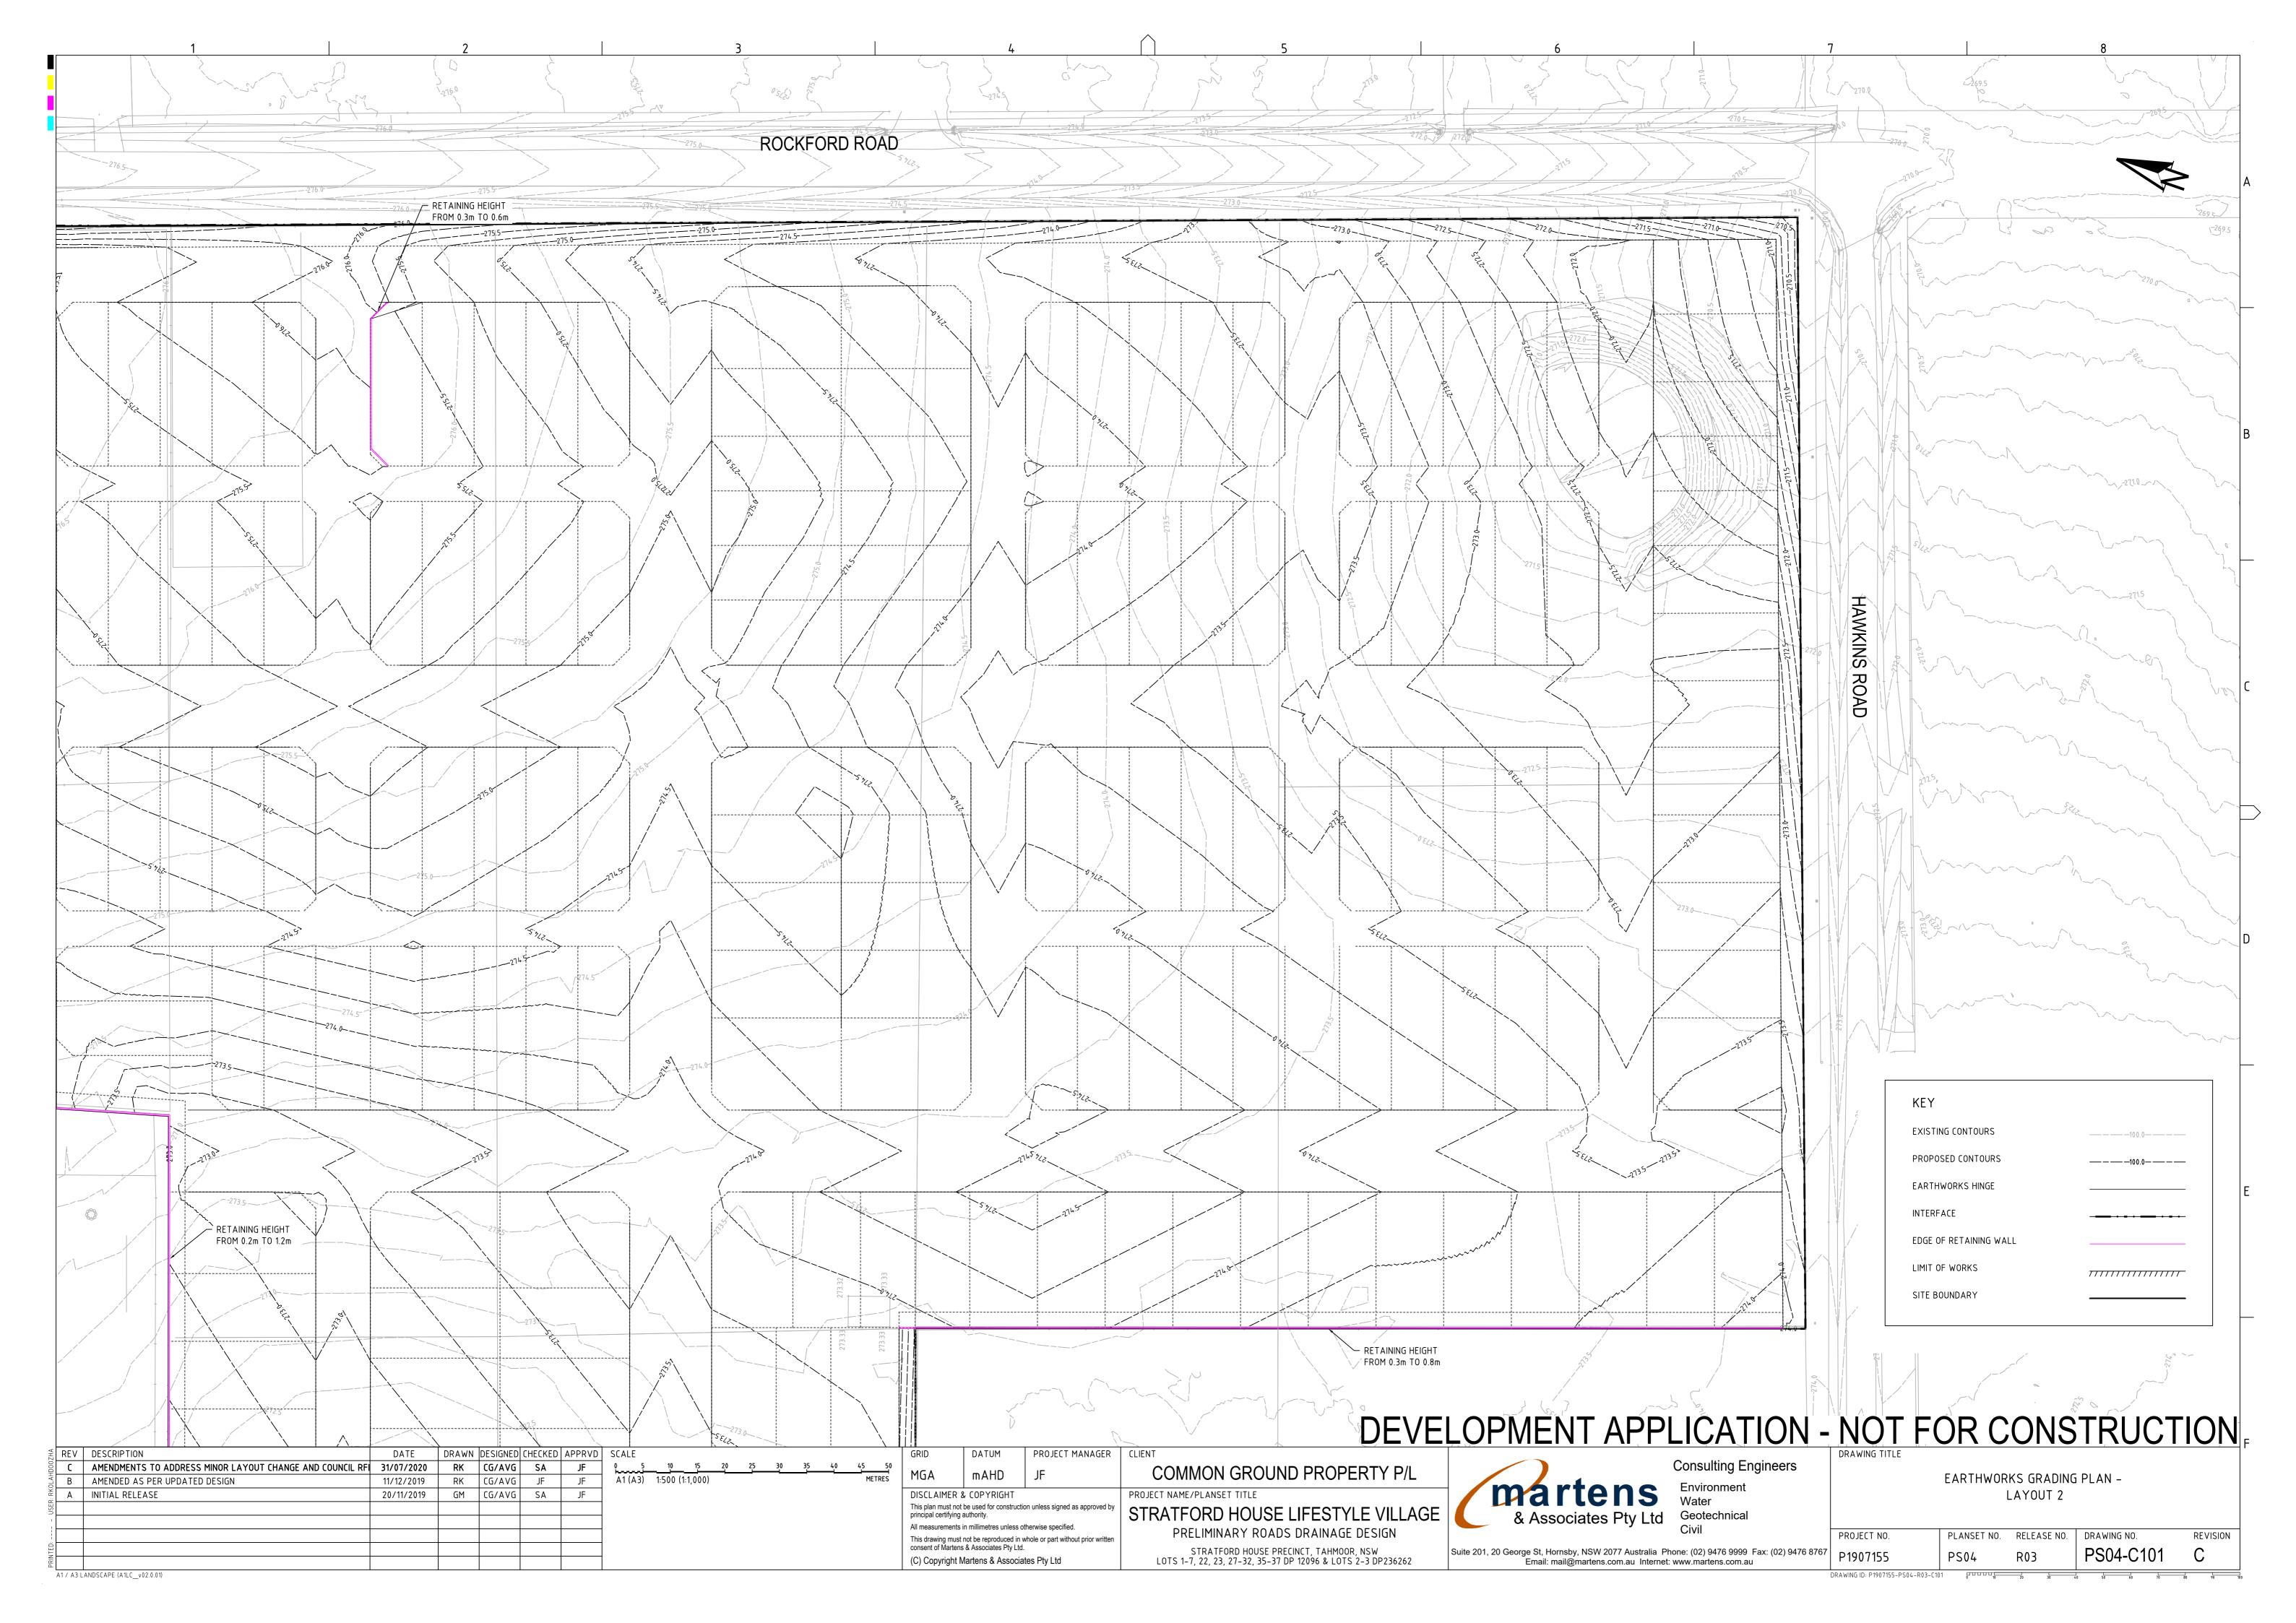
EARTHWORKS SECTION A PLANSET NO. RELEASE NO. DRAWING NO.

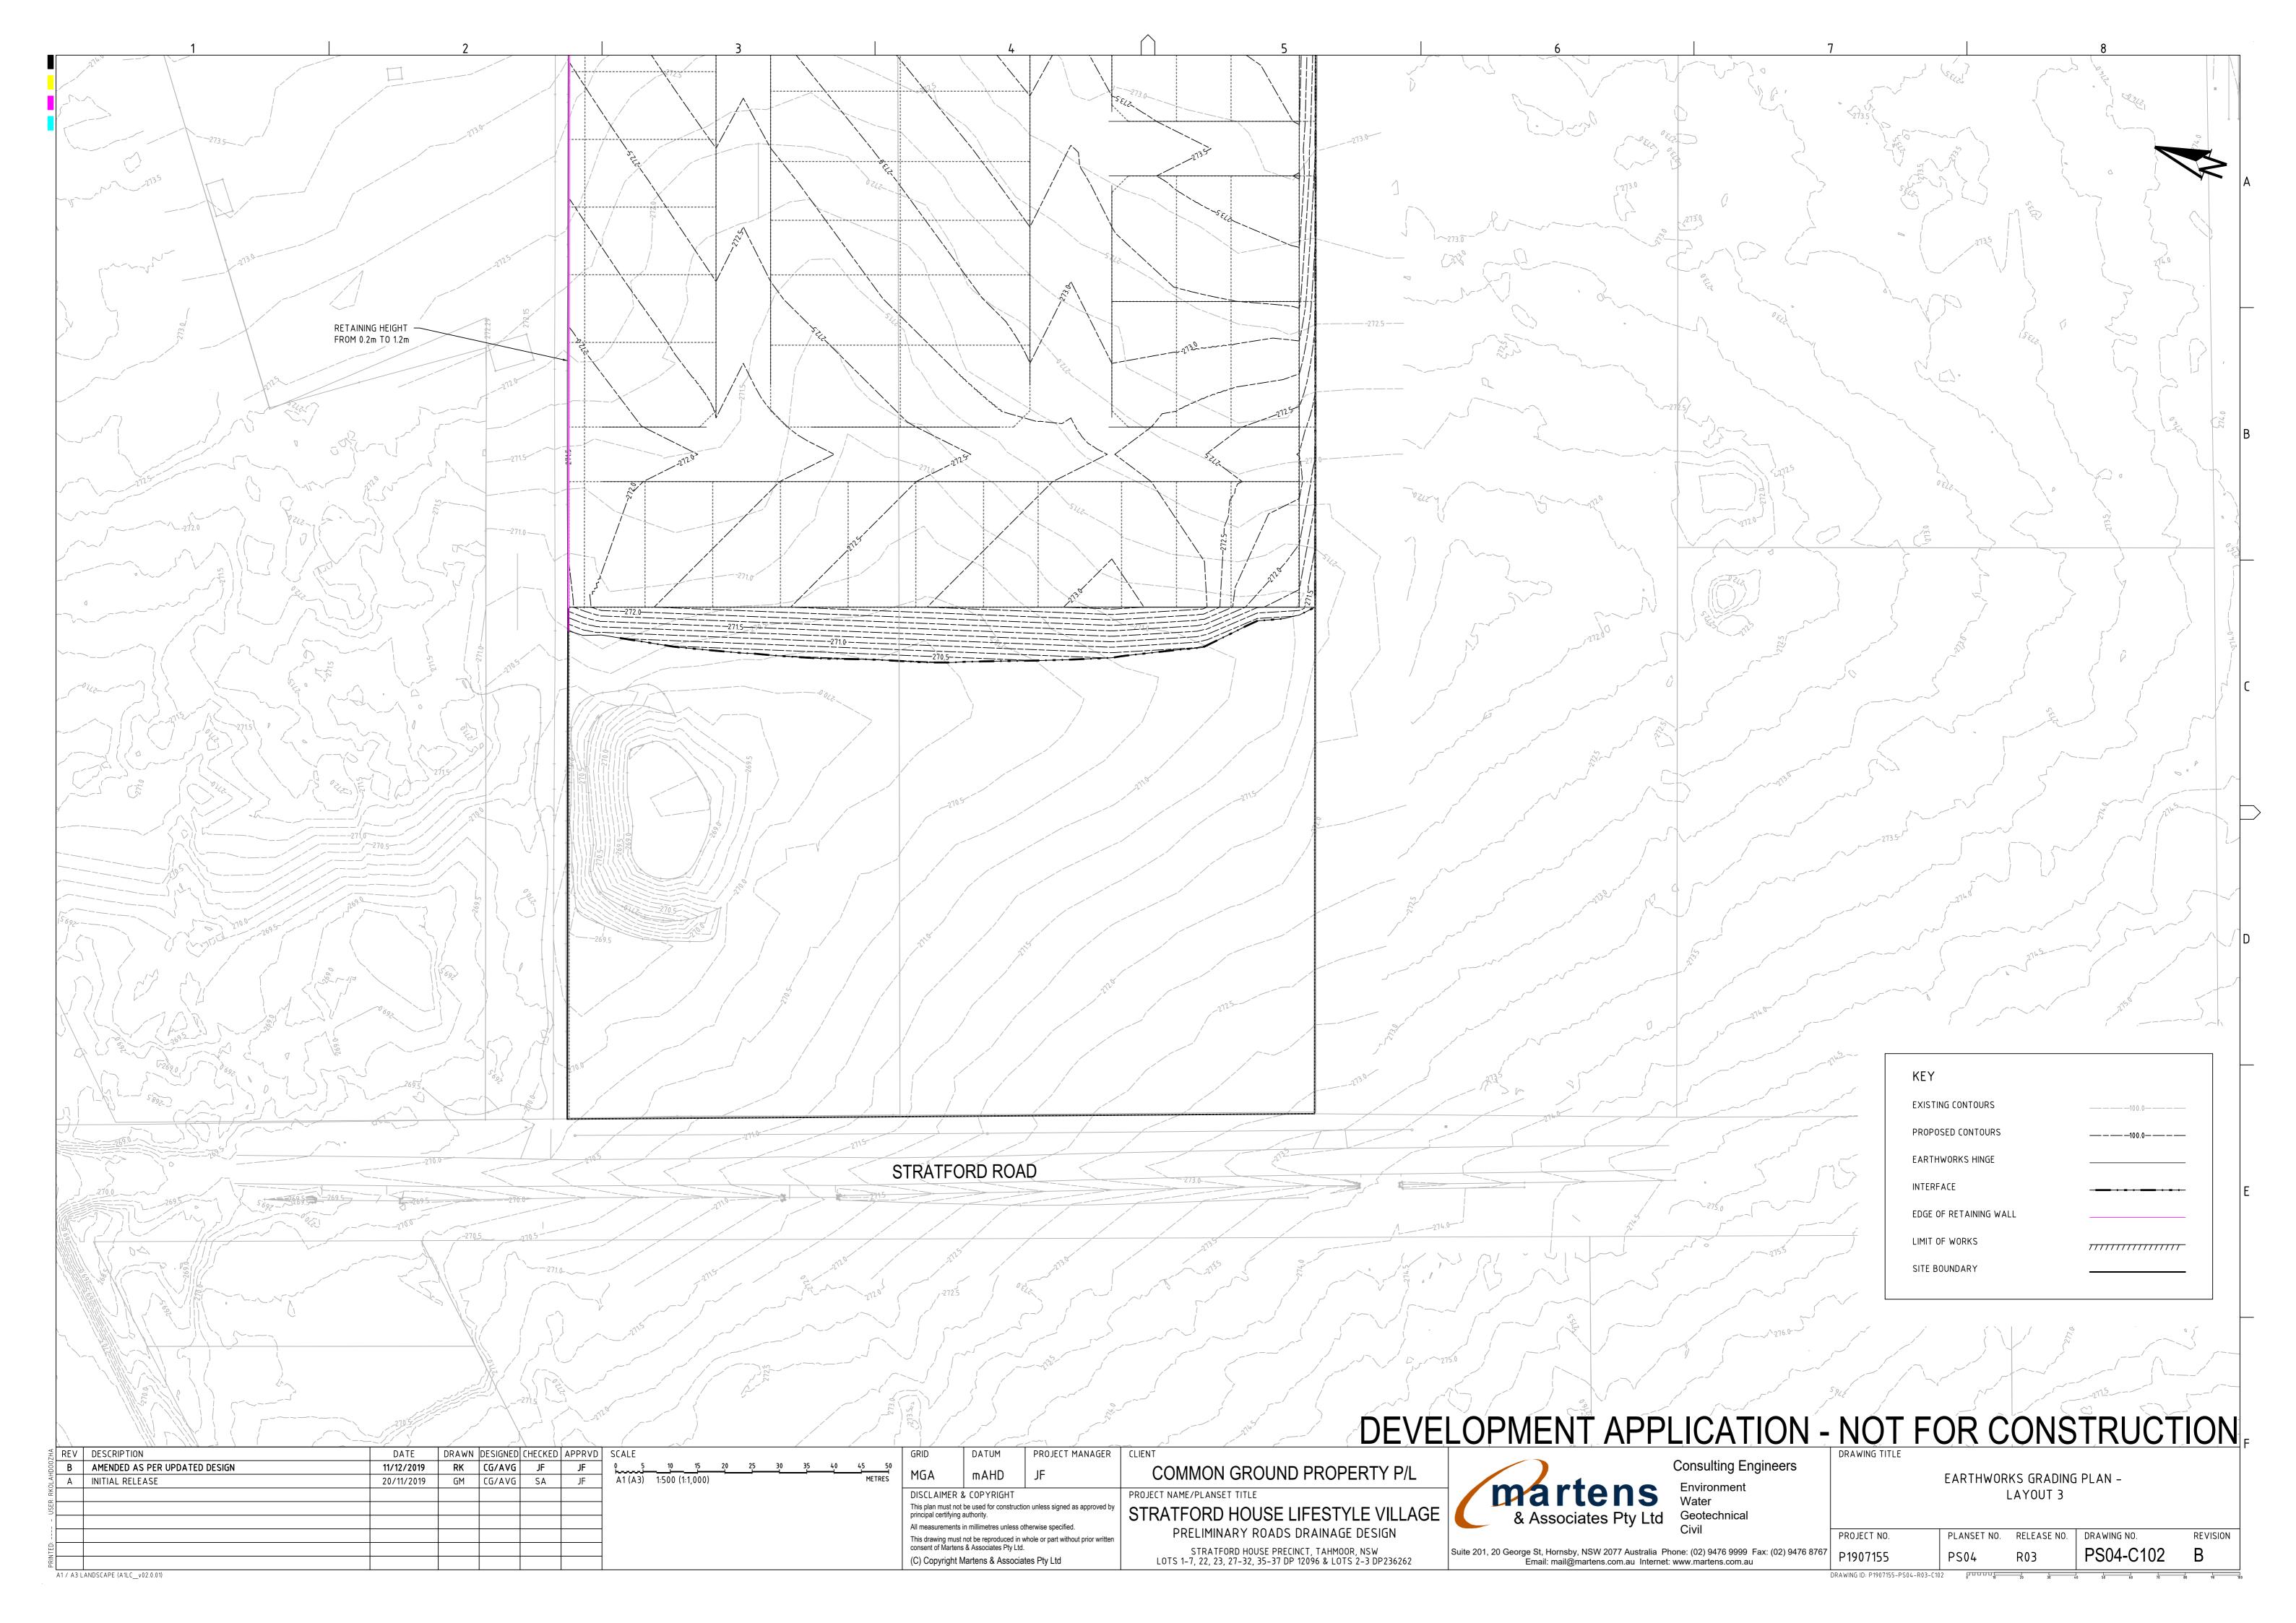
REVISION

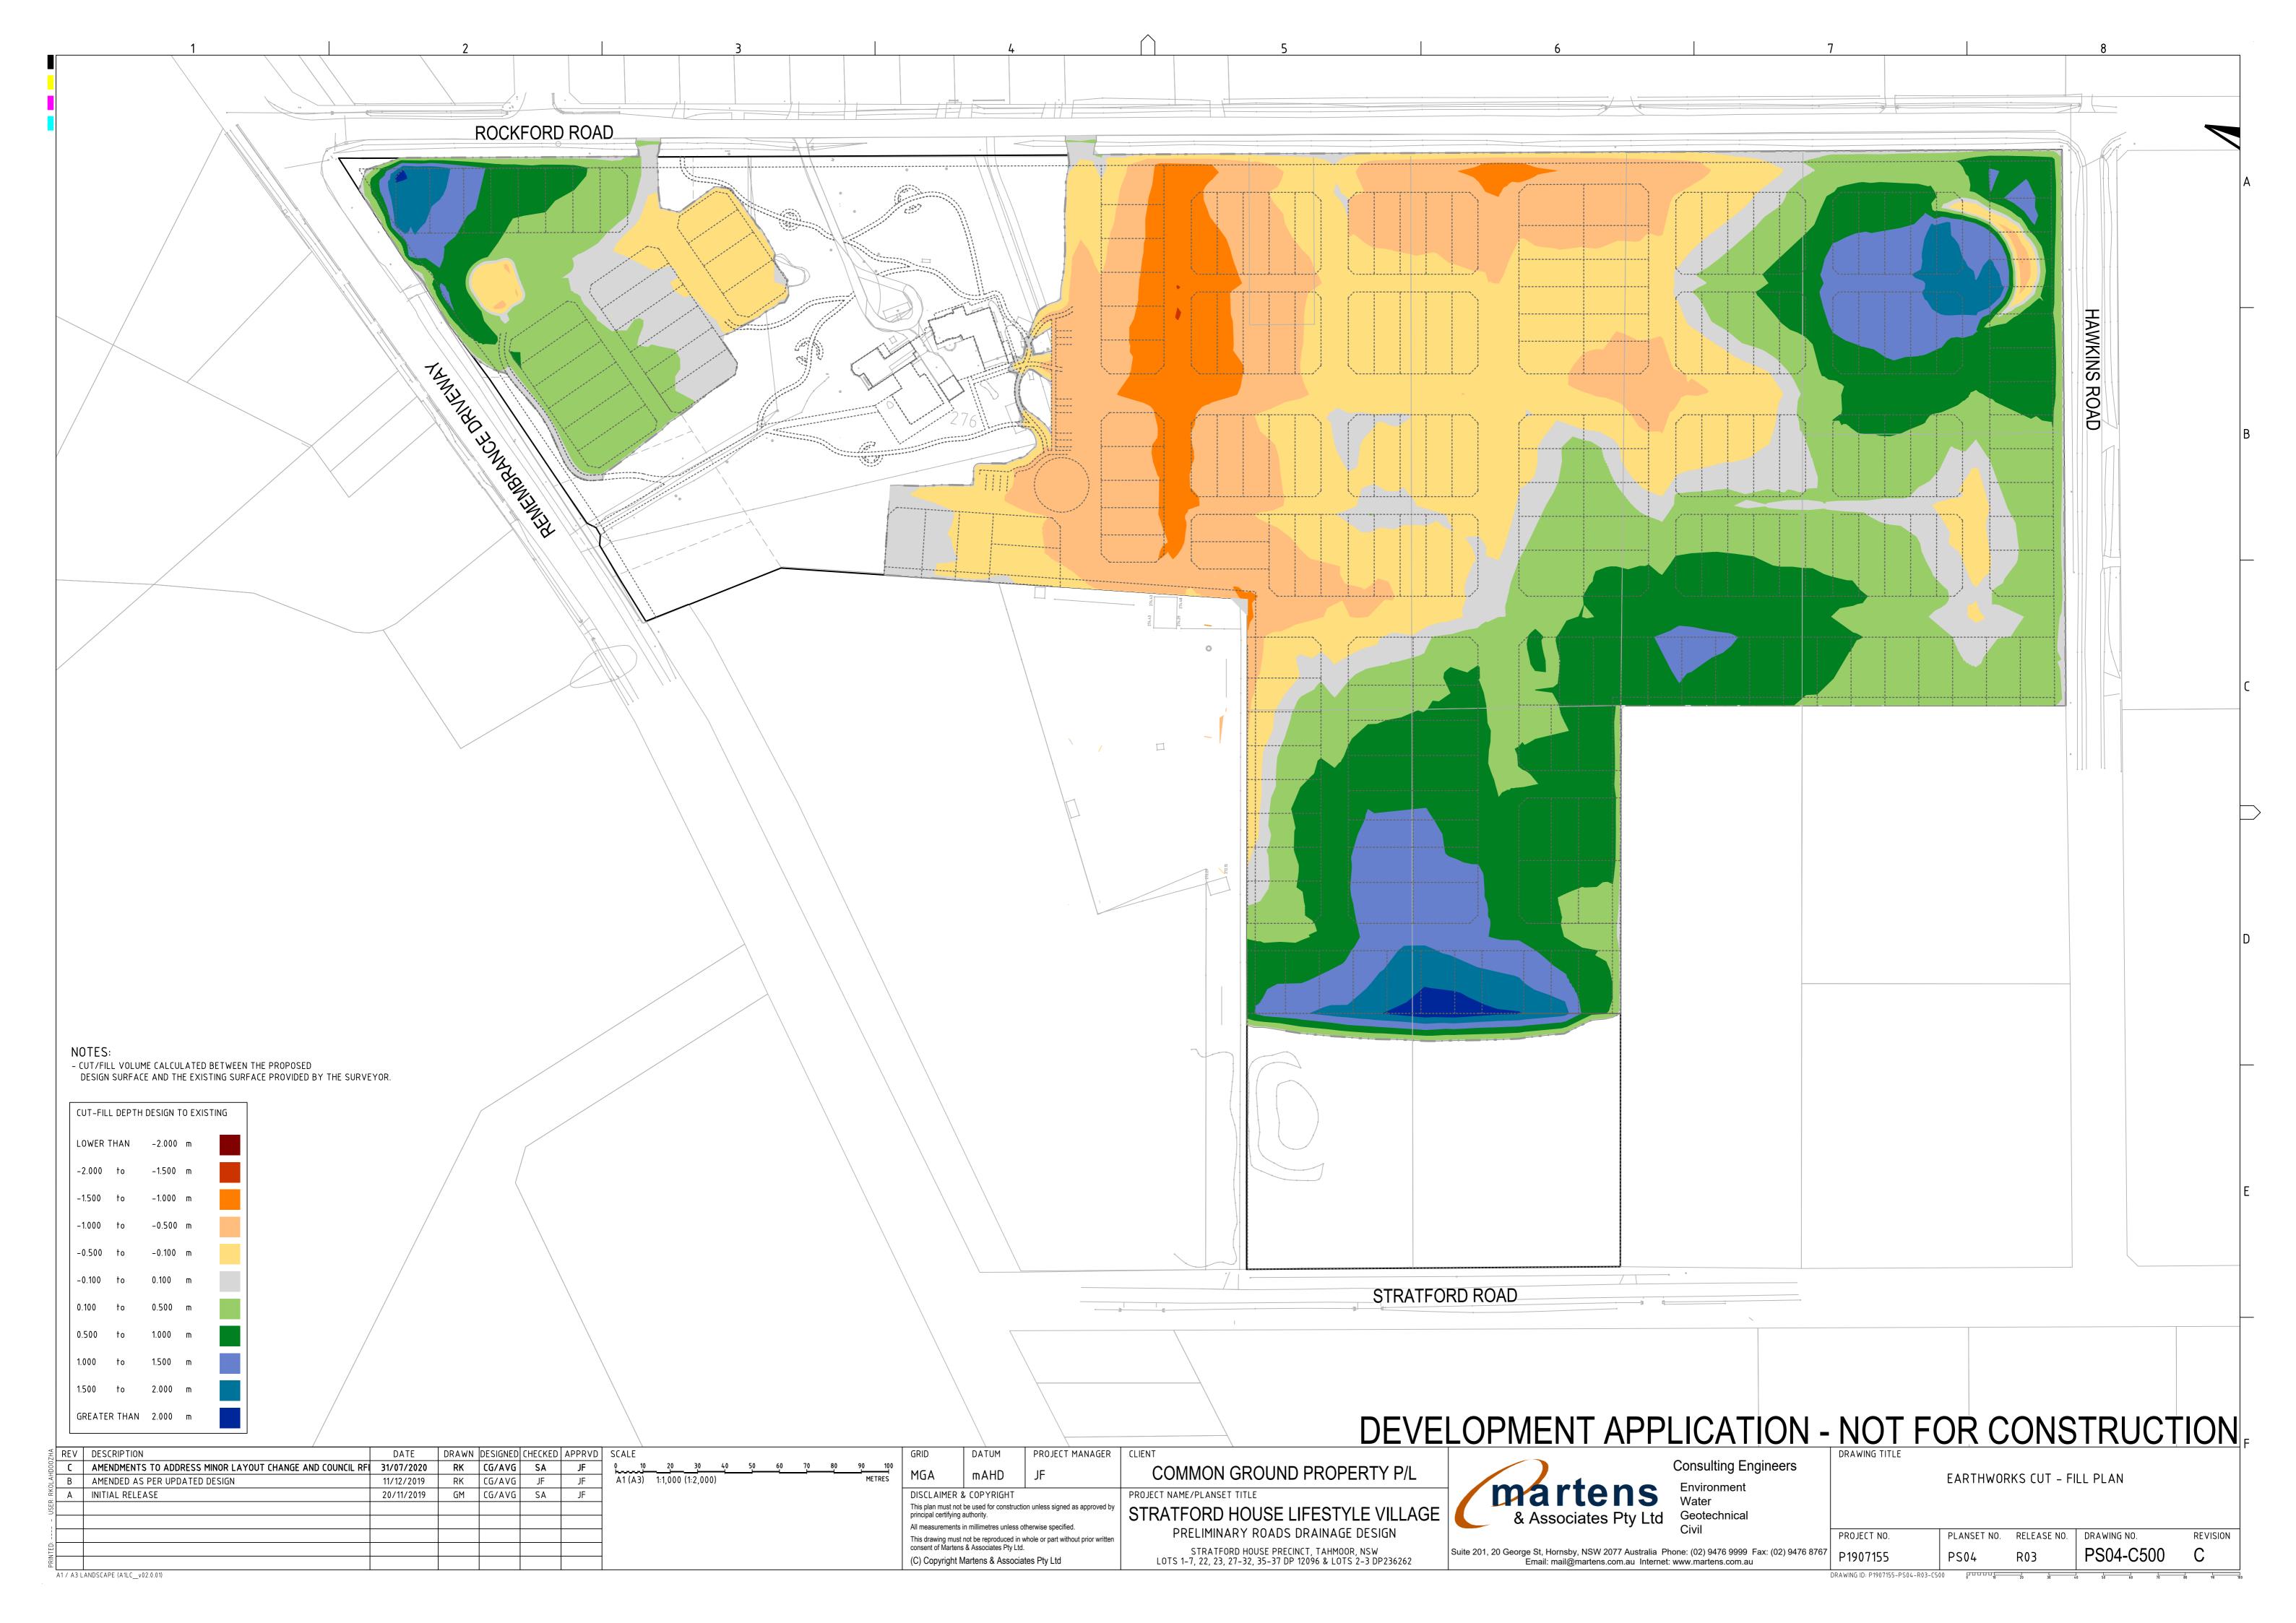
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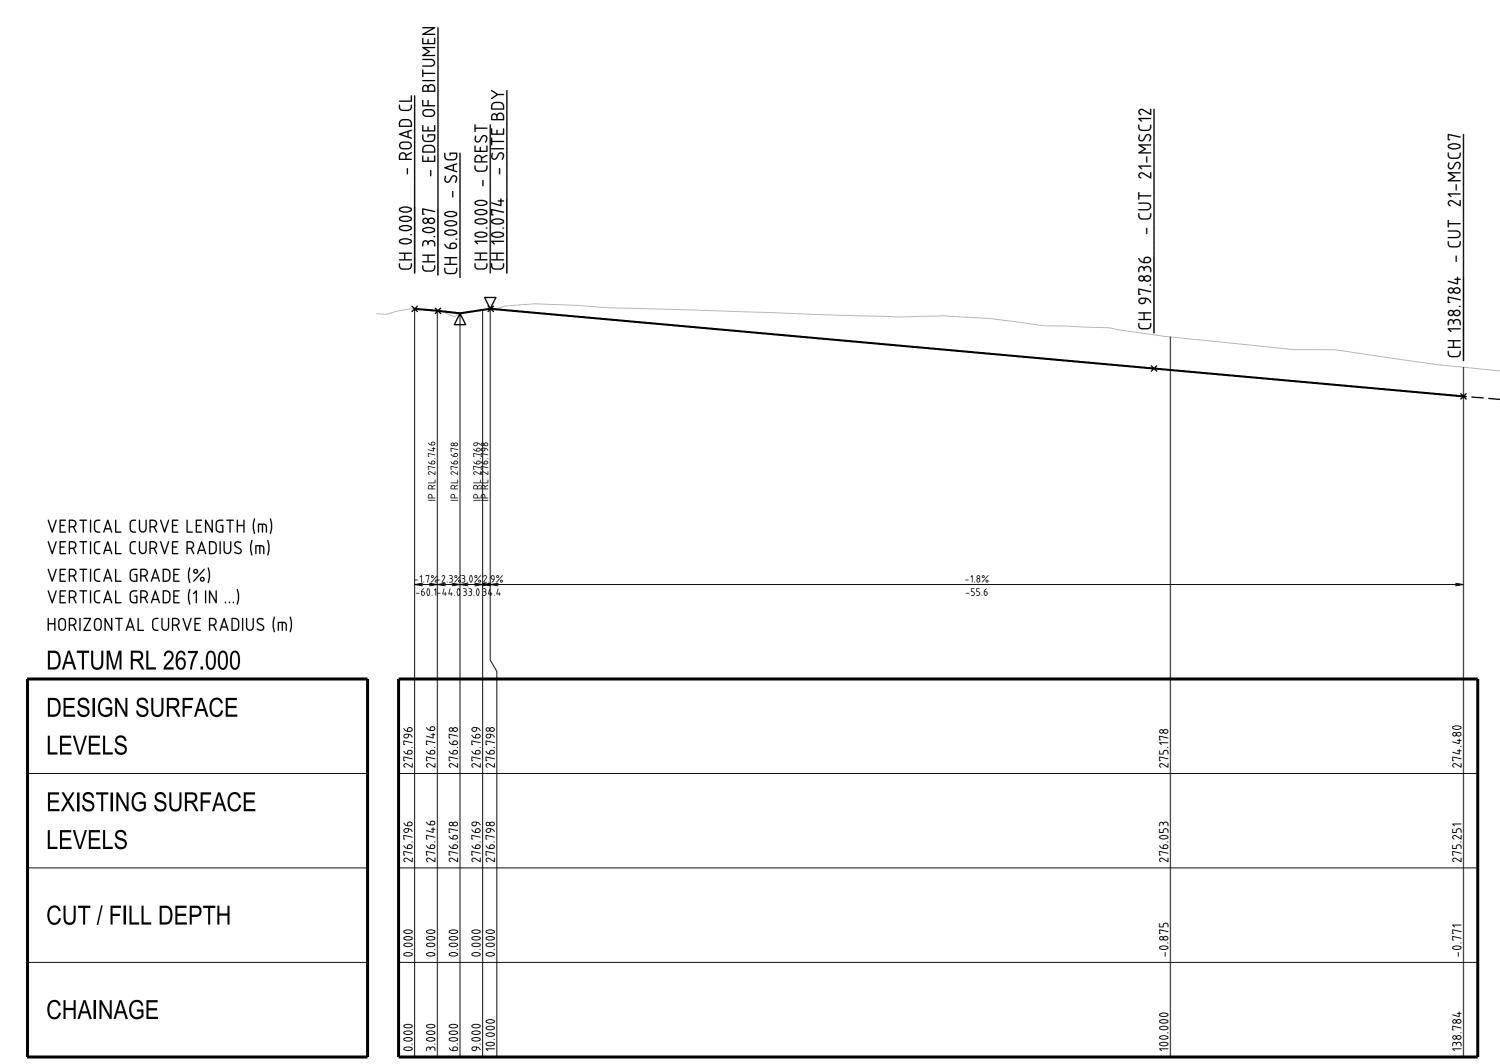


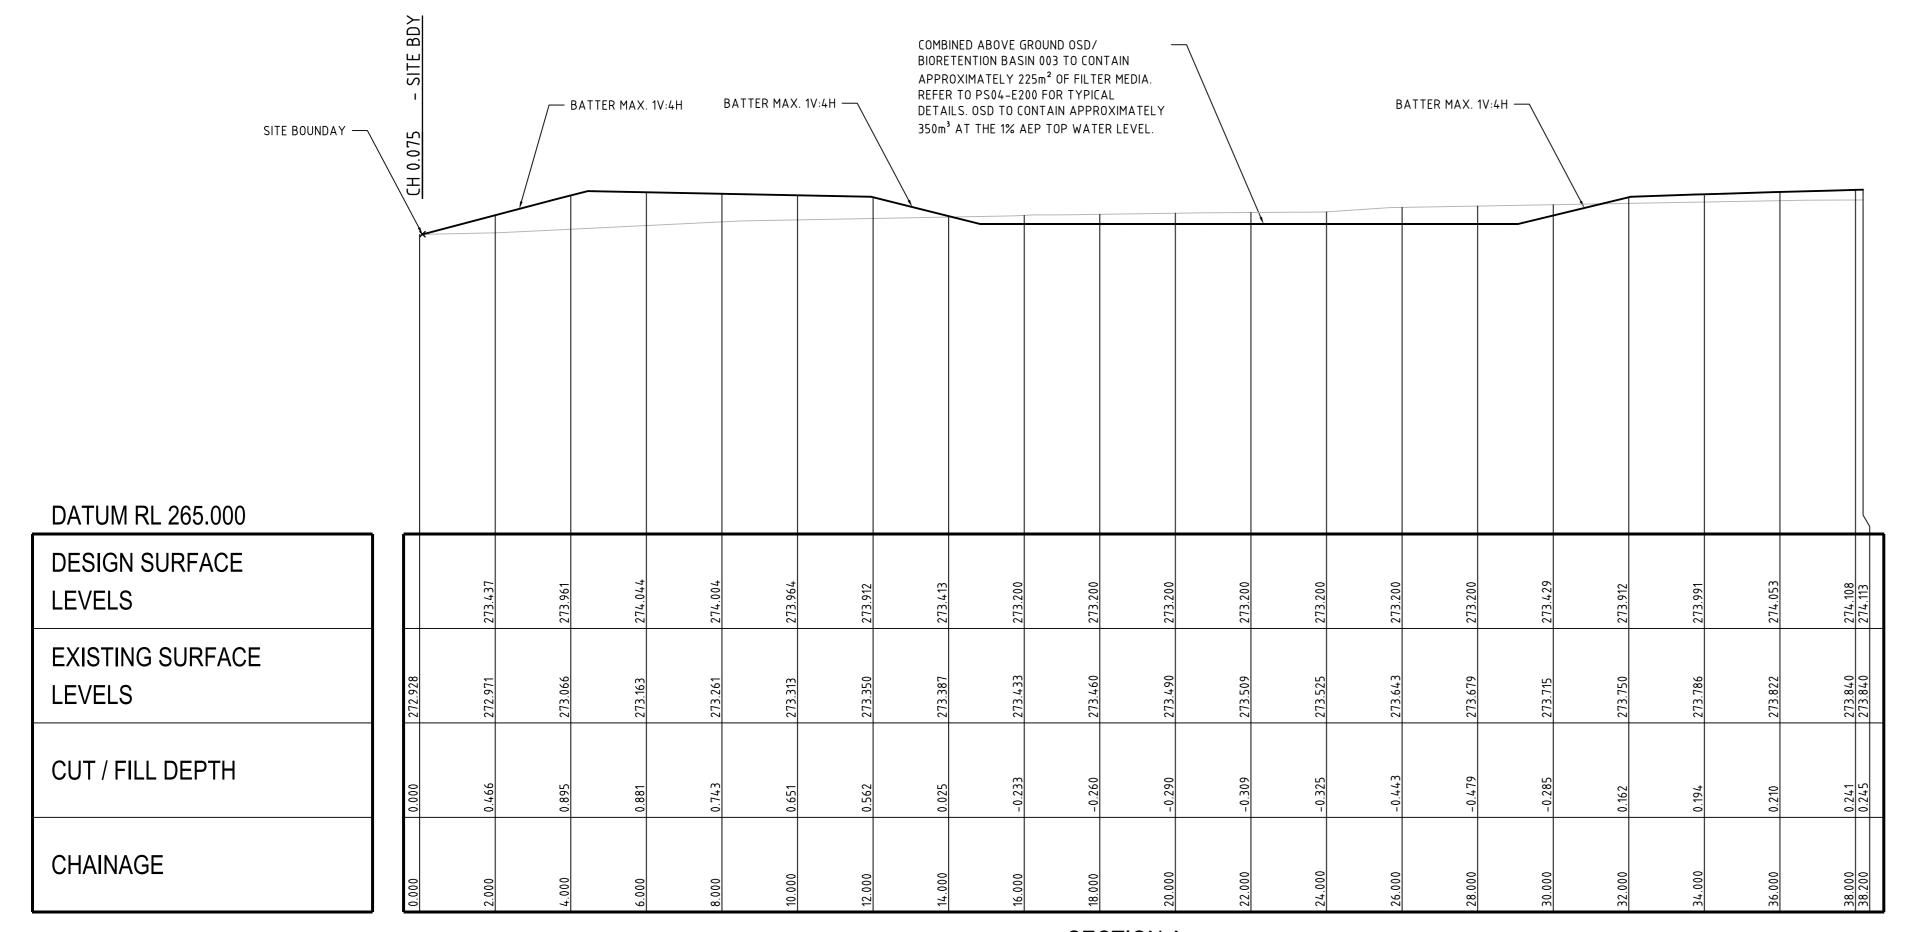

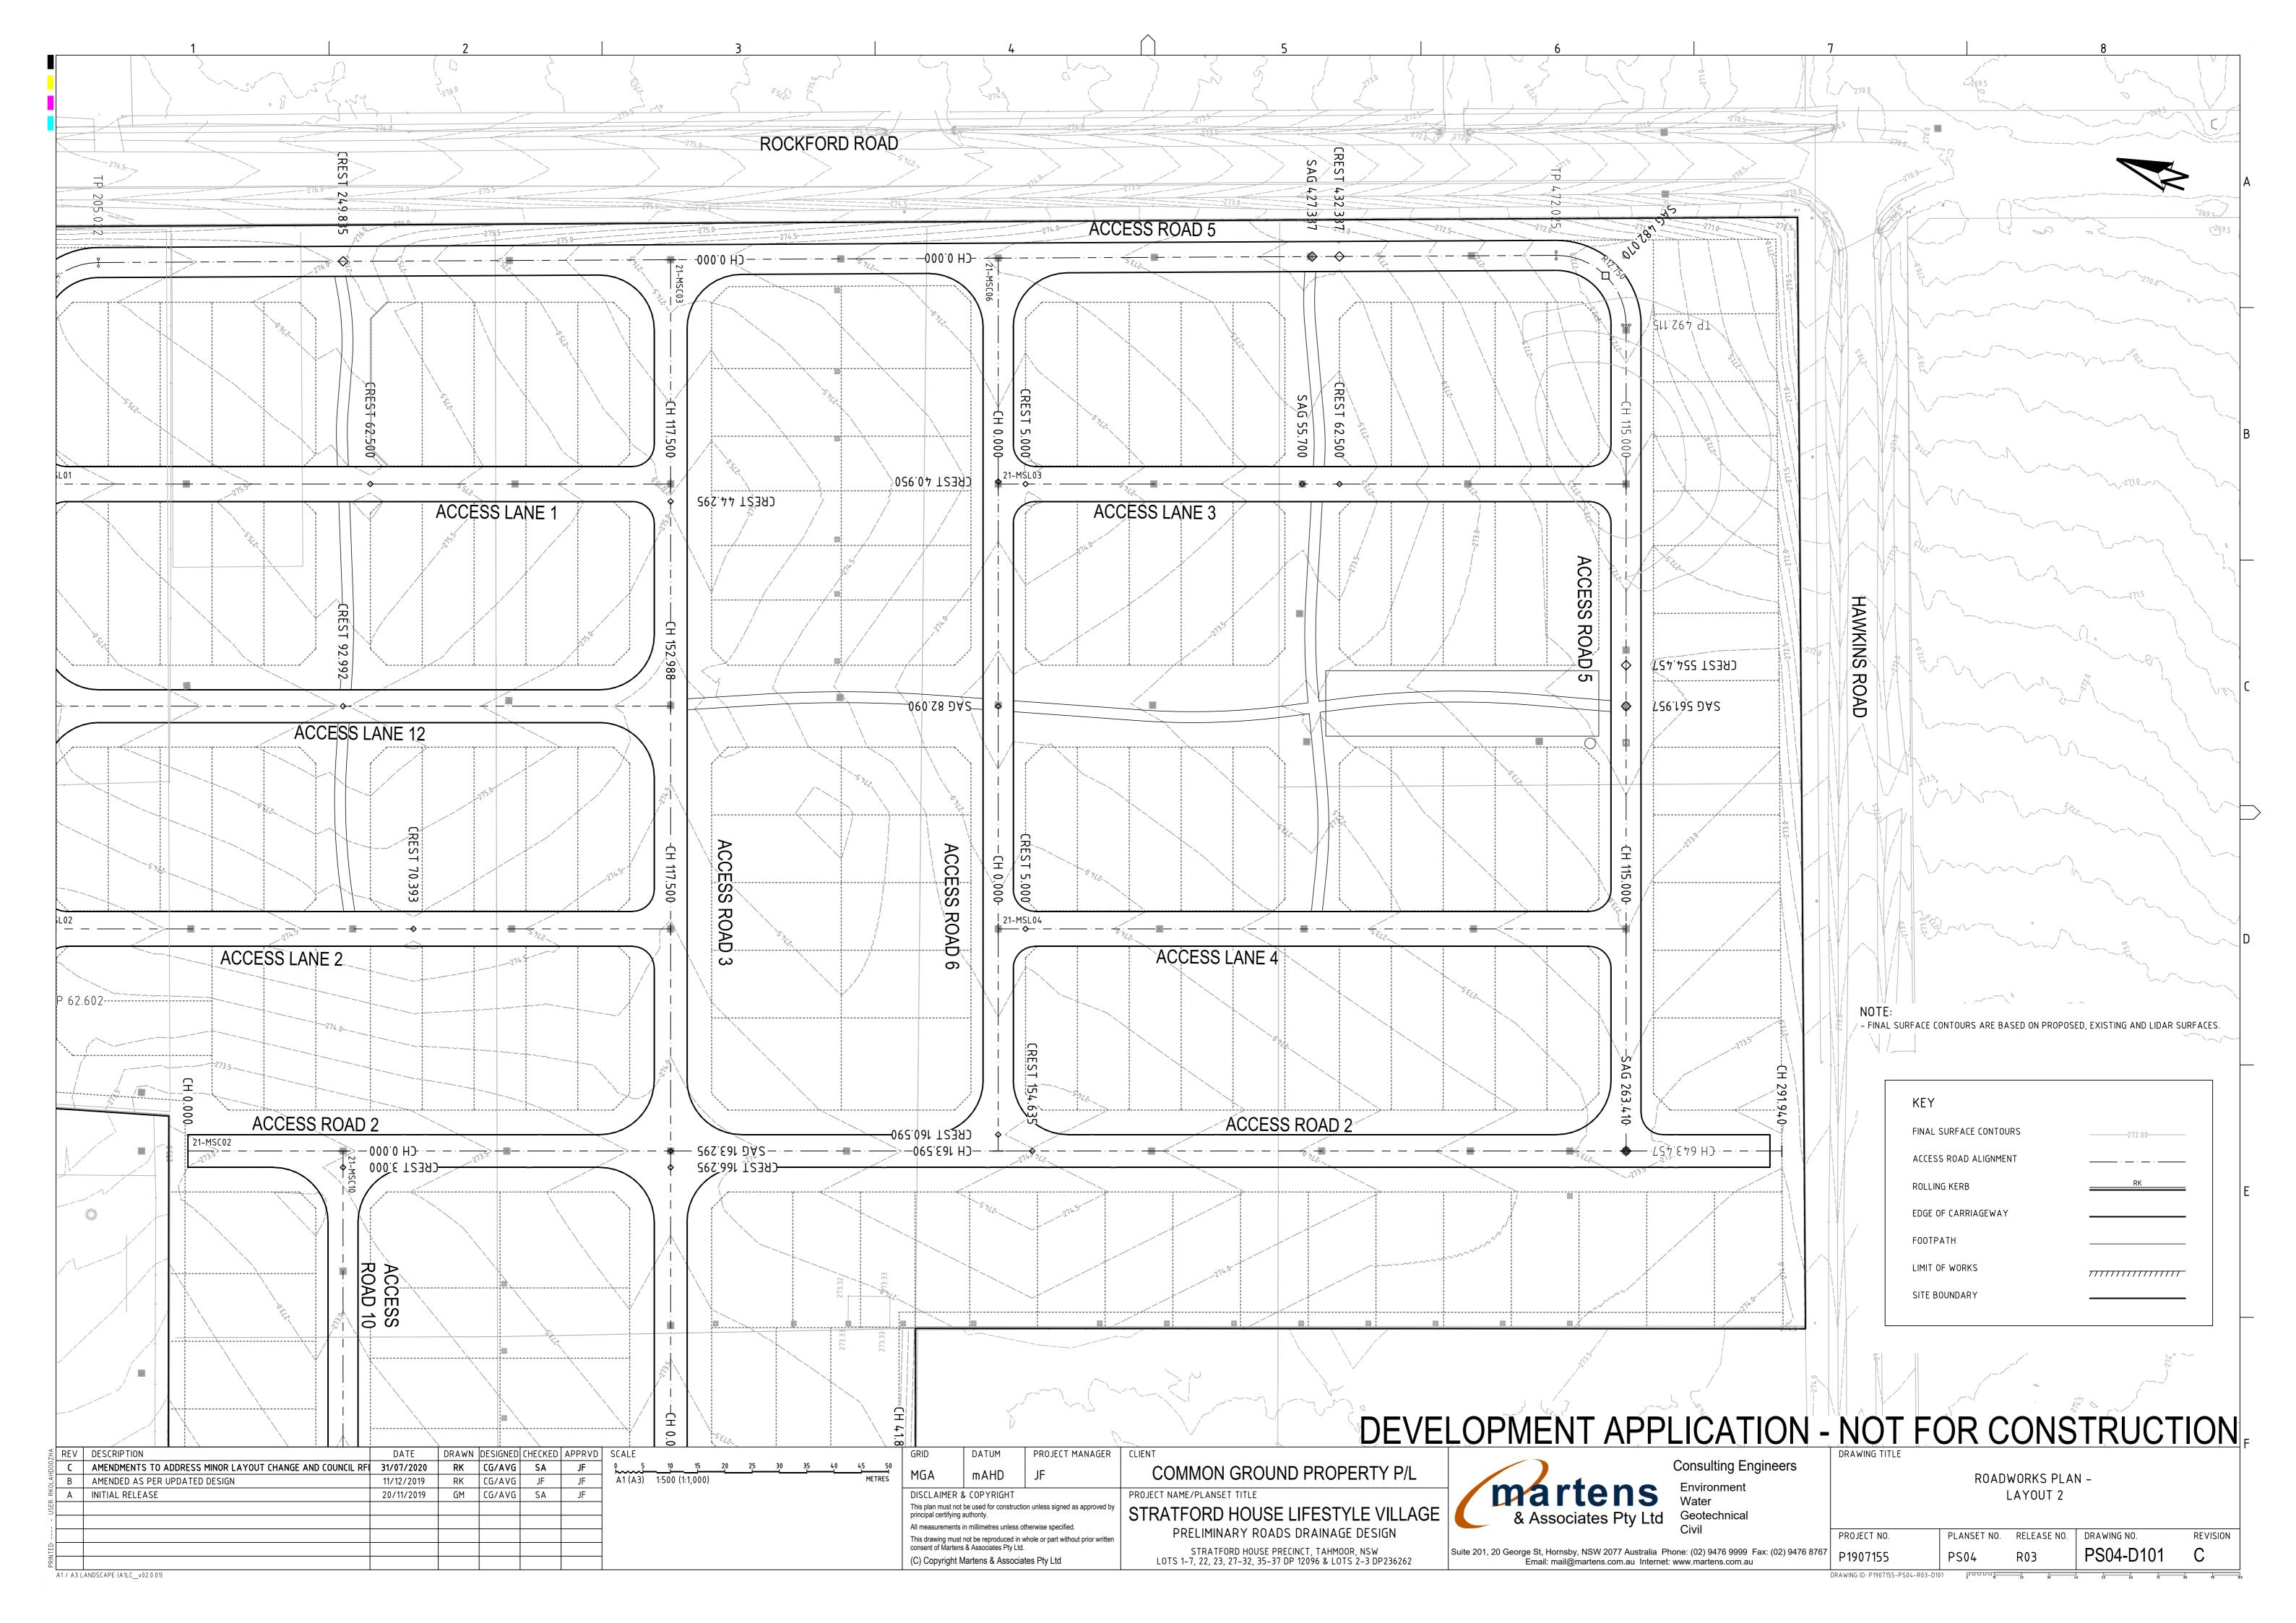

ACCESS ROAD 1 TYPICAL CROSS SECTION

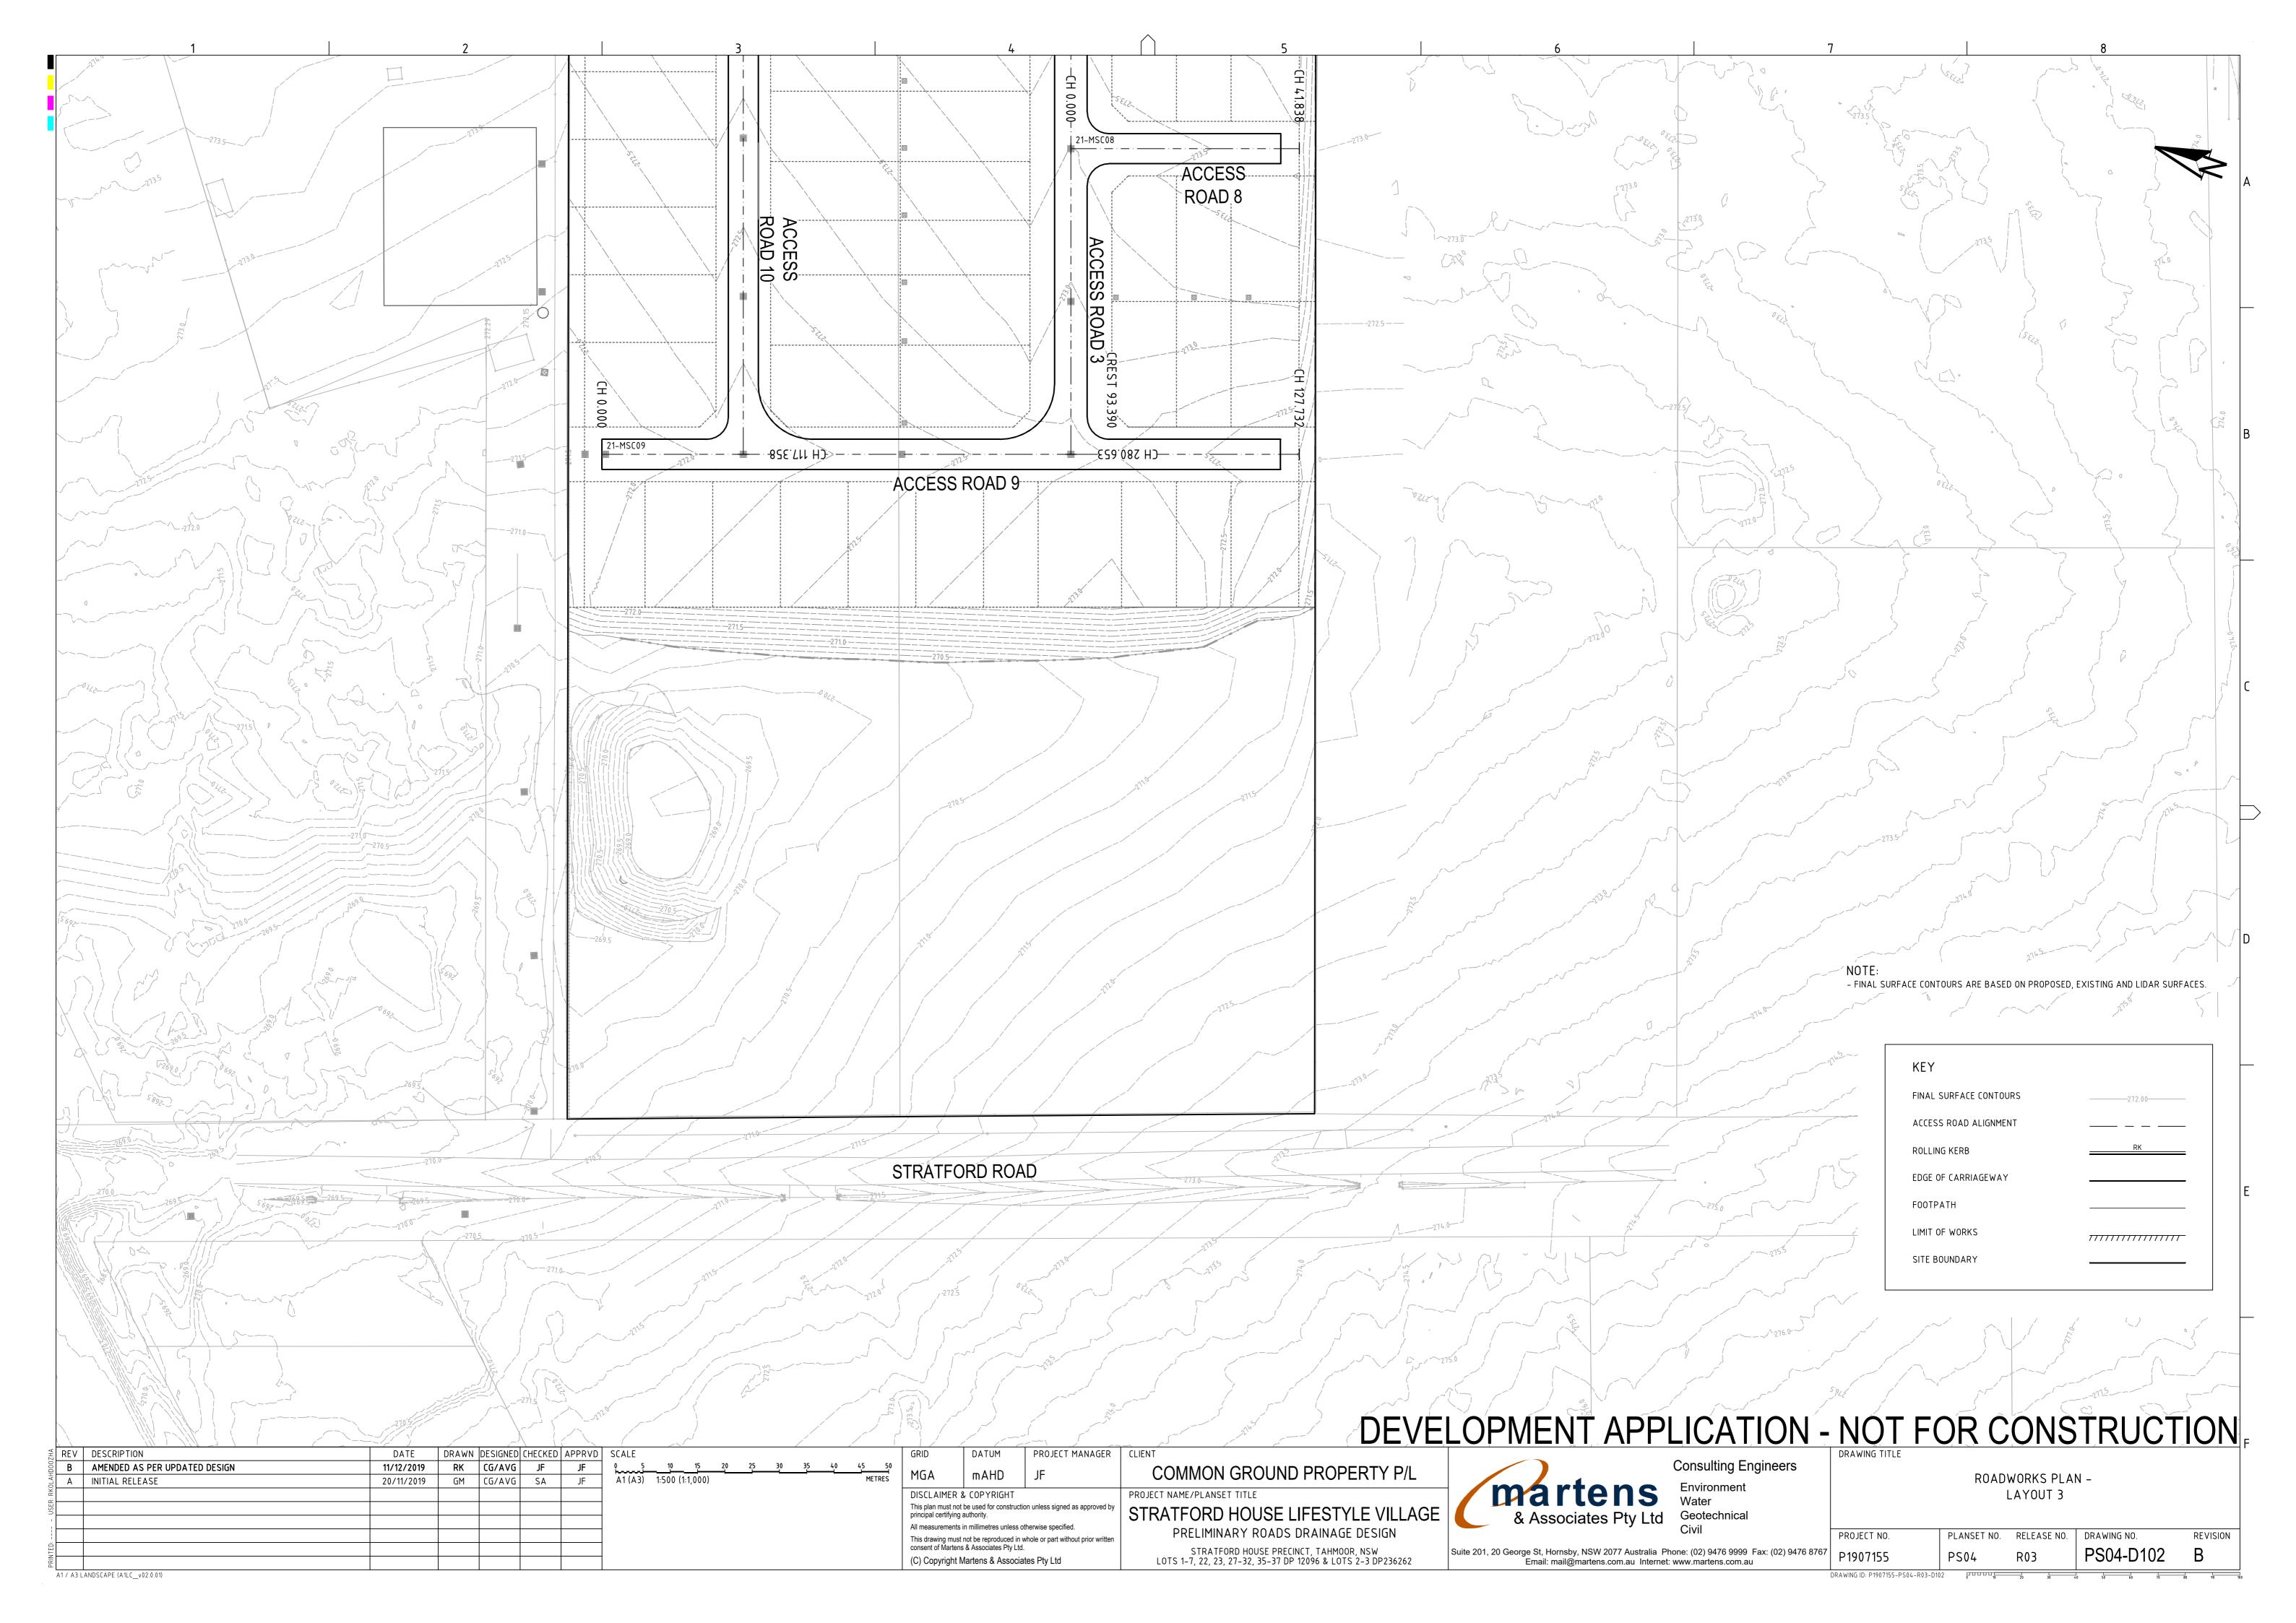SCALE 1:100

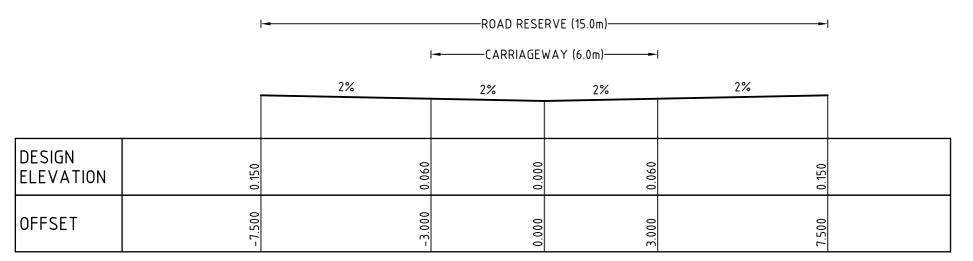

ACCESS ROAD 1 (21-MSC01) LONG. SECTION


SCALE: HORIZONTAL - 1:500 VERTICAL - 1:100


DEVELOPMENT APPLICATION - NOT FOR CONSTRUCTION FOR CONSTR


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TED					1				1	tens & Associates Pty Lt		STRATFORD HOUSE PRECINCT, TAHMOOR, NSW	Suite 201, 20 George St, Hornsby, NSW 2077 Australia Ph	'hone: (02) 9476 9999 Fax: (02) 9476 8767
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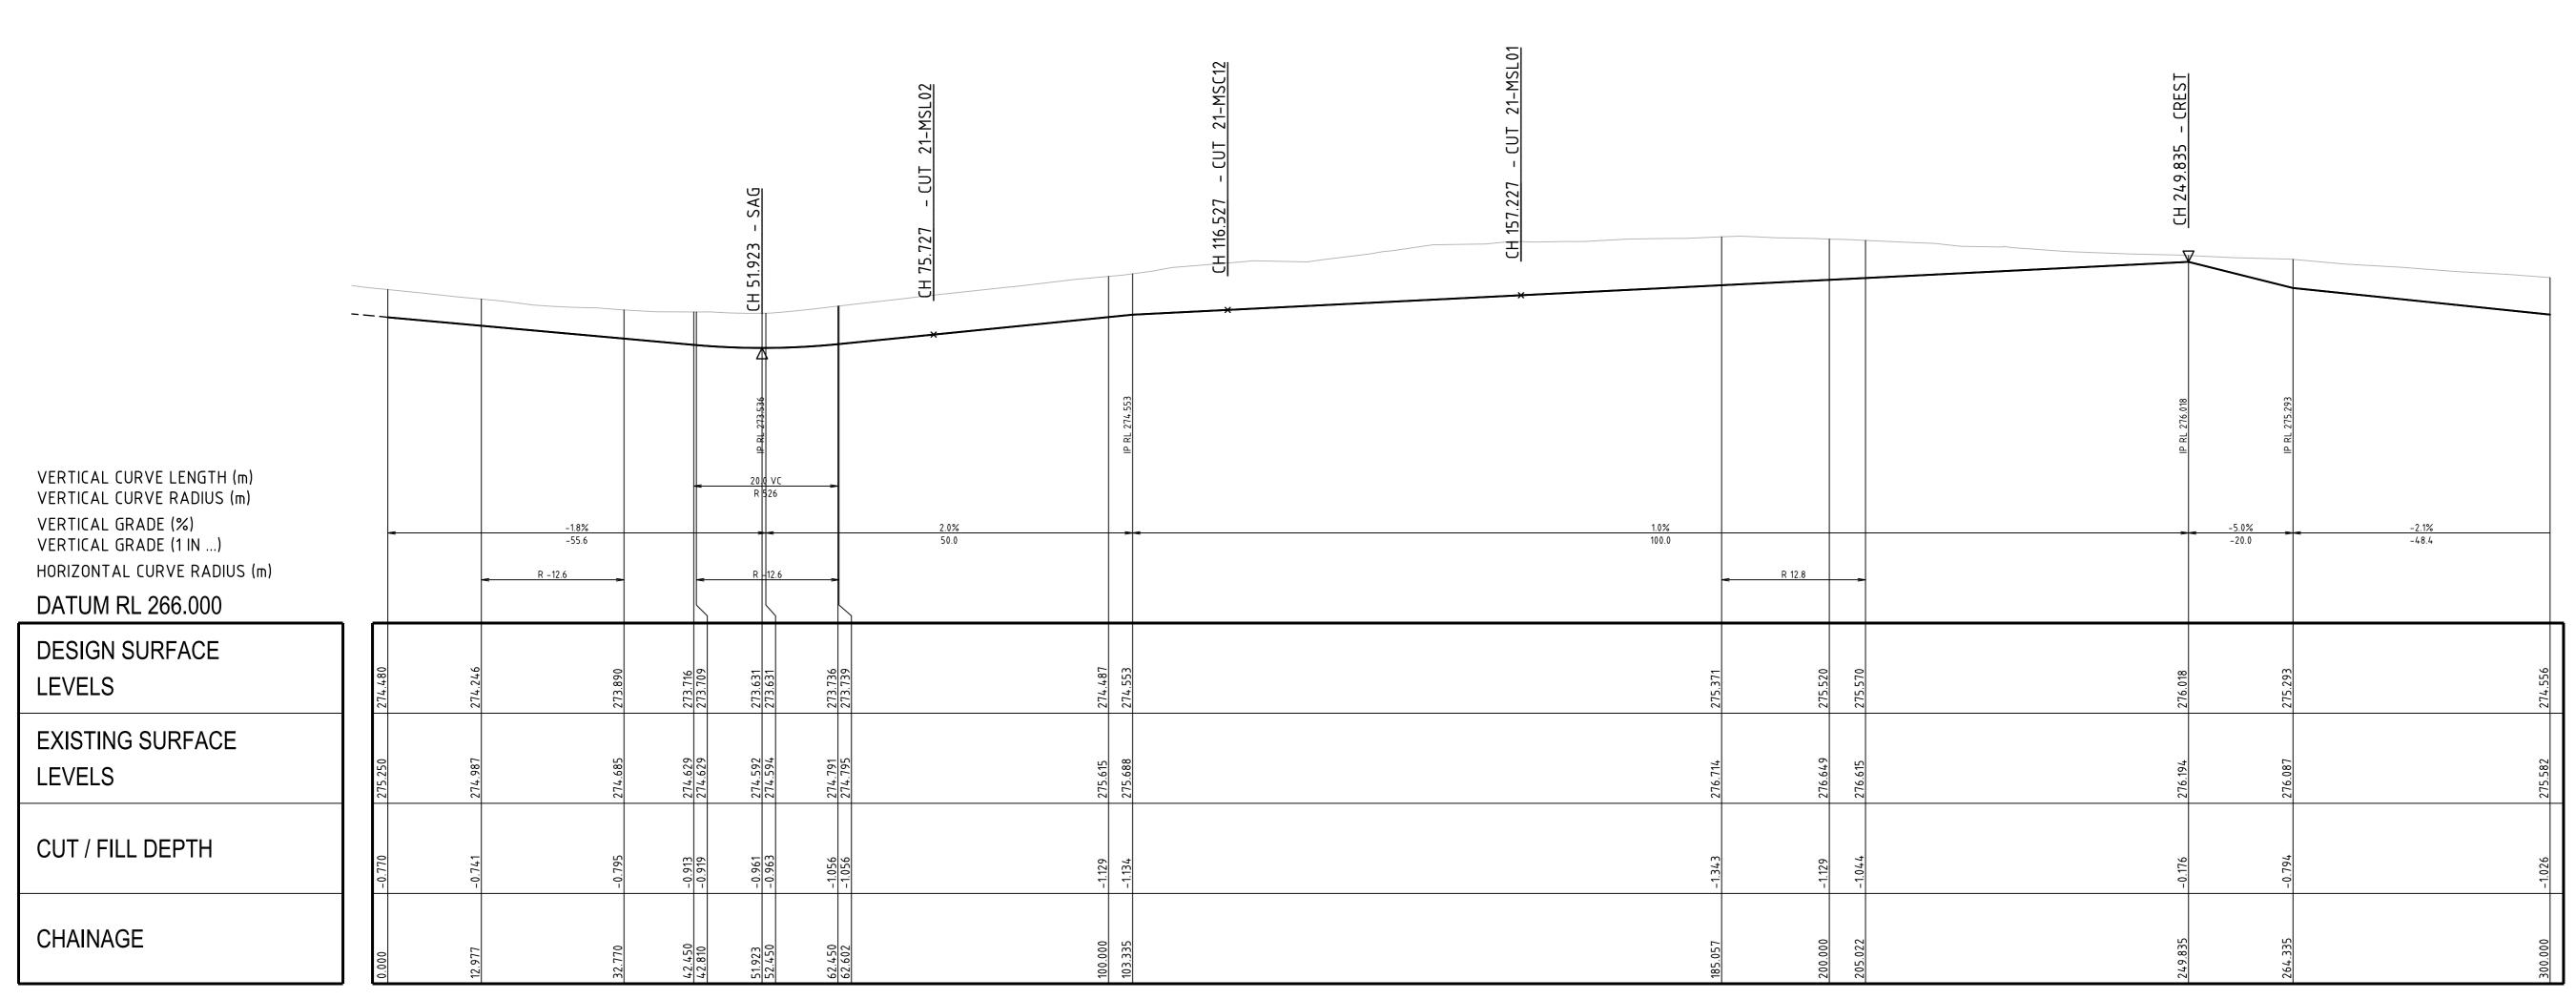
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& Associates Pty Ltd	

ACCESS ROAD 1 (21-MSC01) LONG. SECTION AND TYPICAL CROSS SECTION PROJECT NO. PLANSET NO. RELEASE NO. DRAWING NO. REVISION PS04-D200



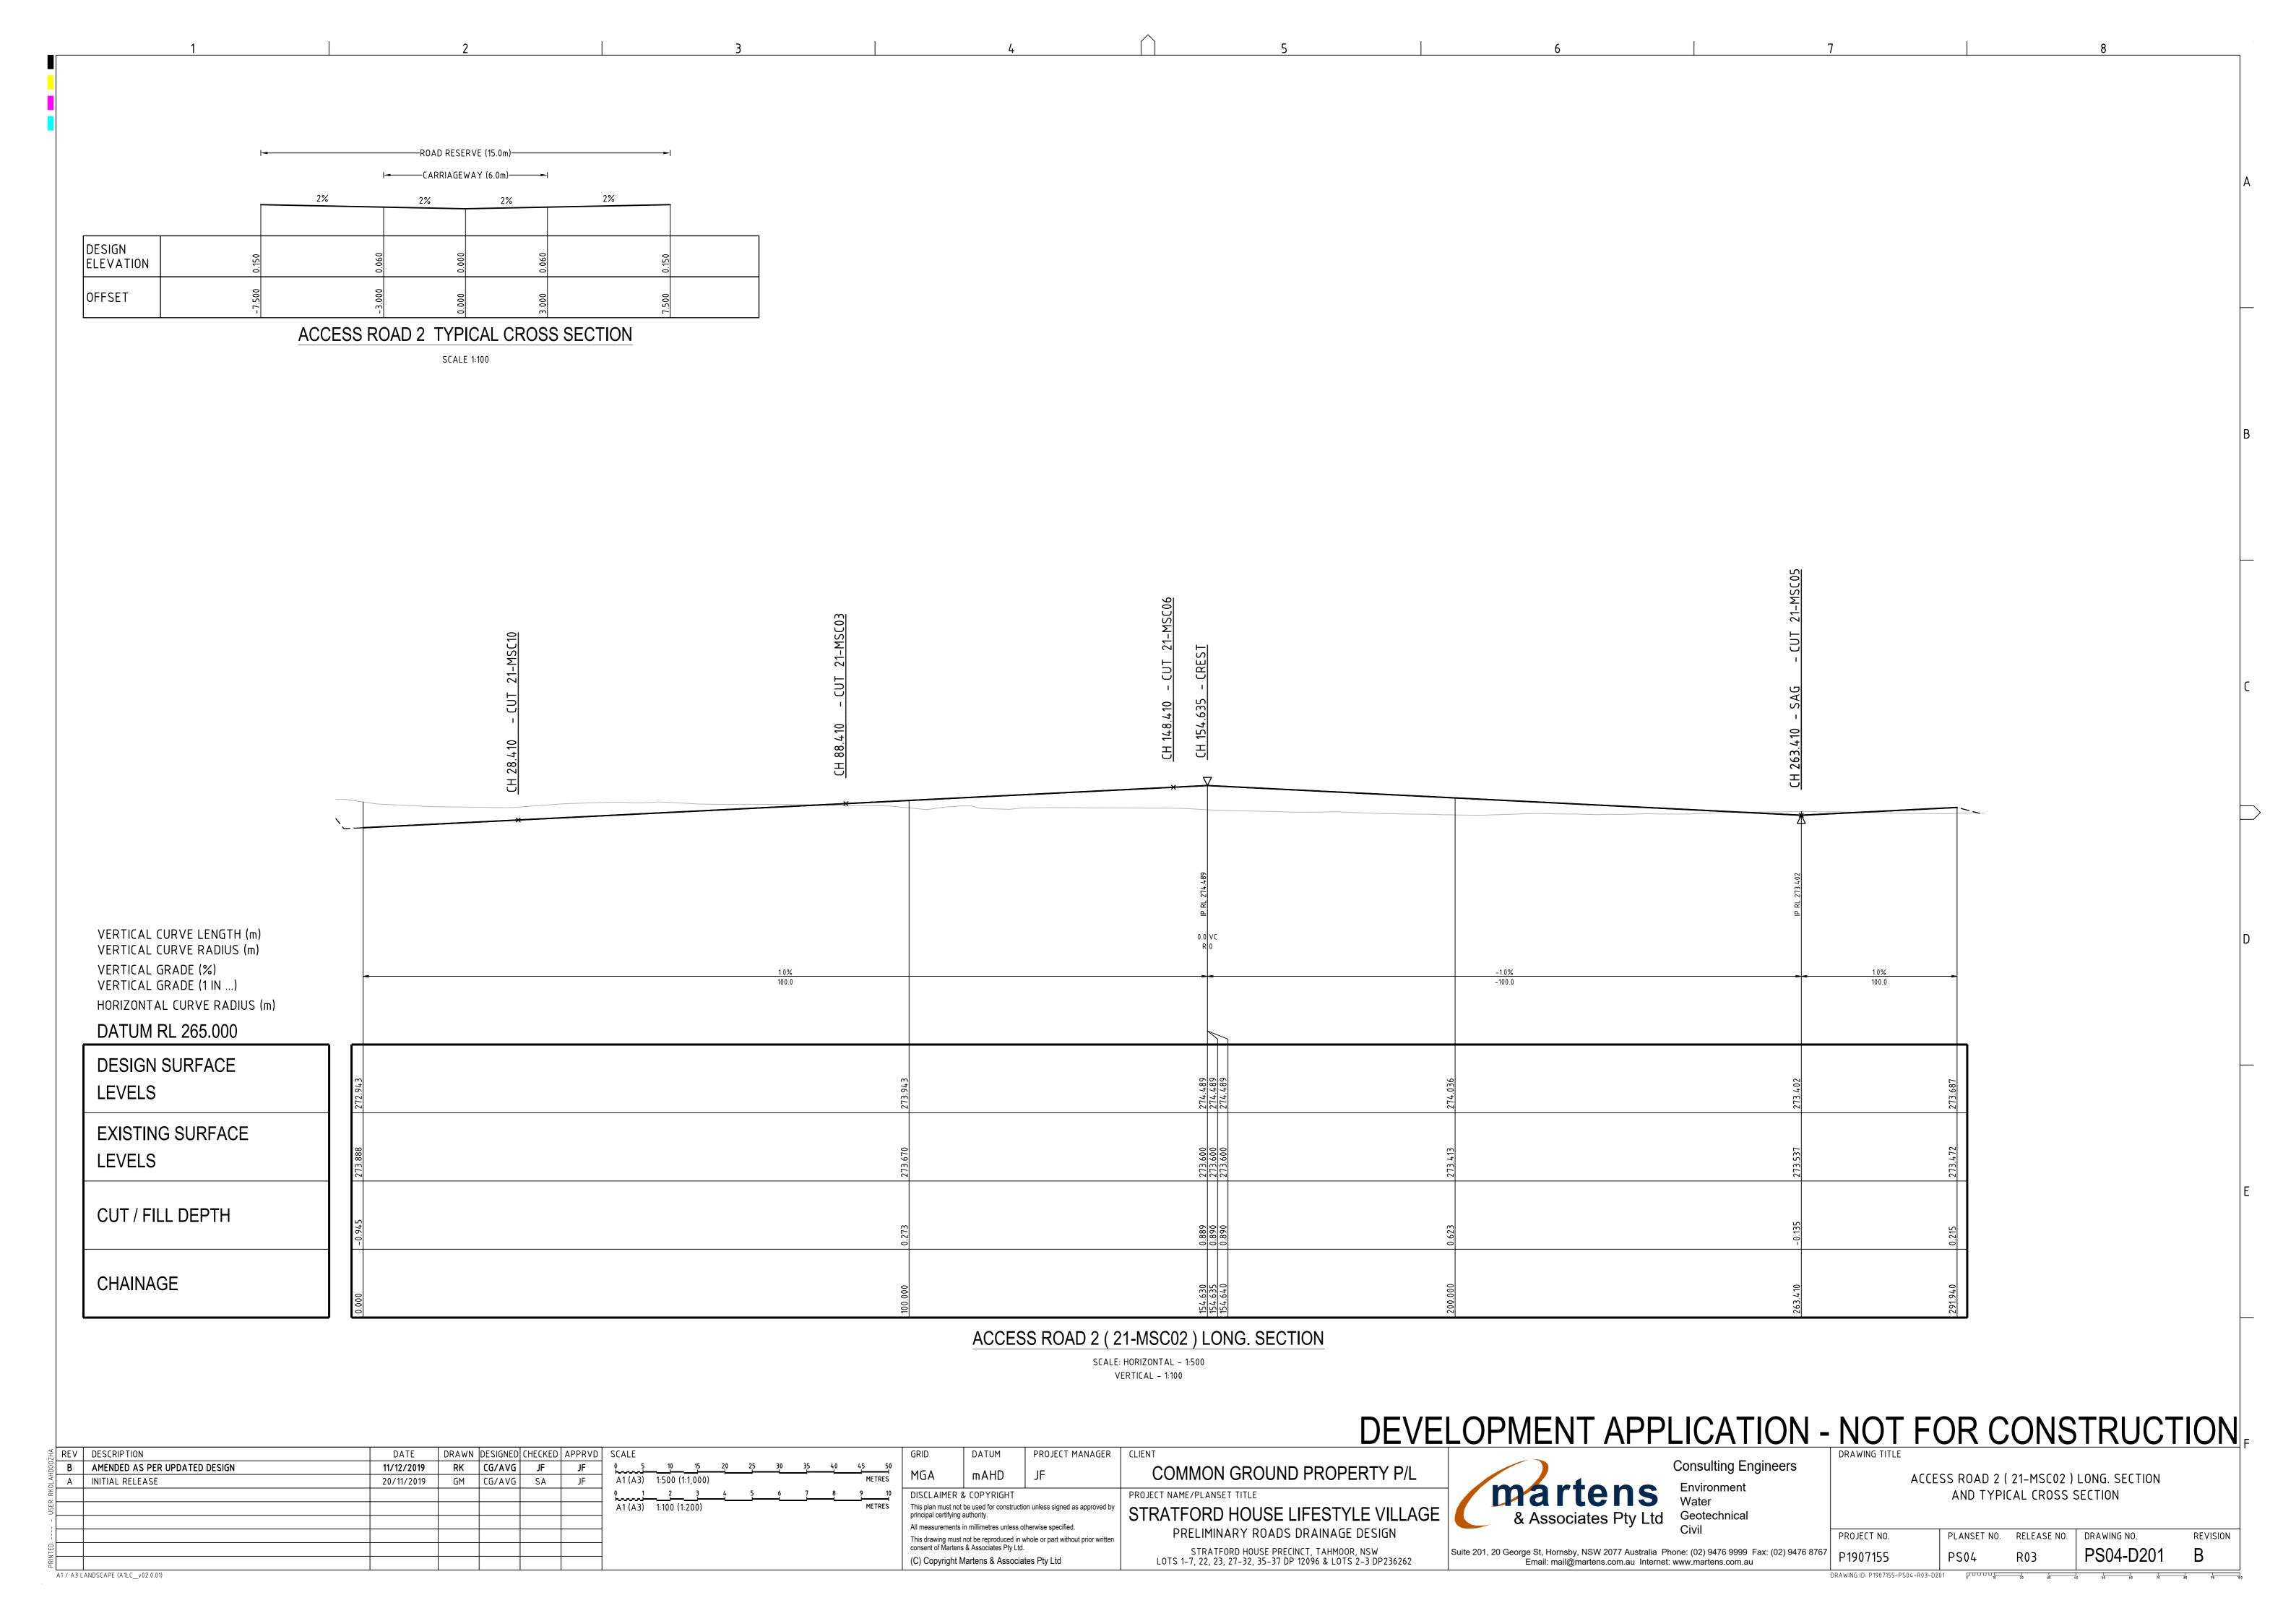

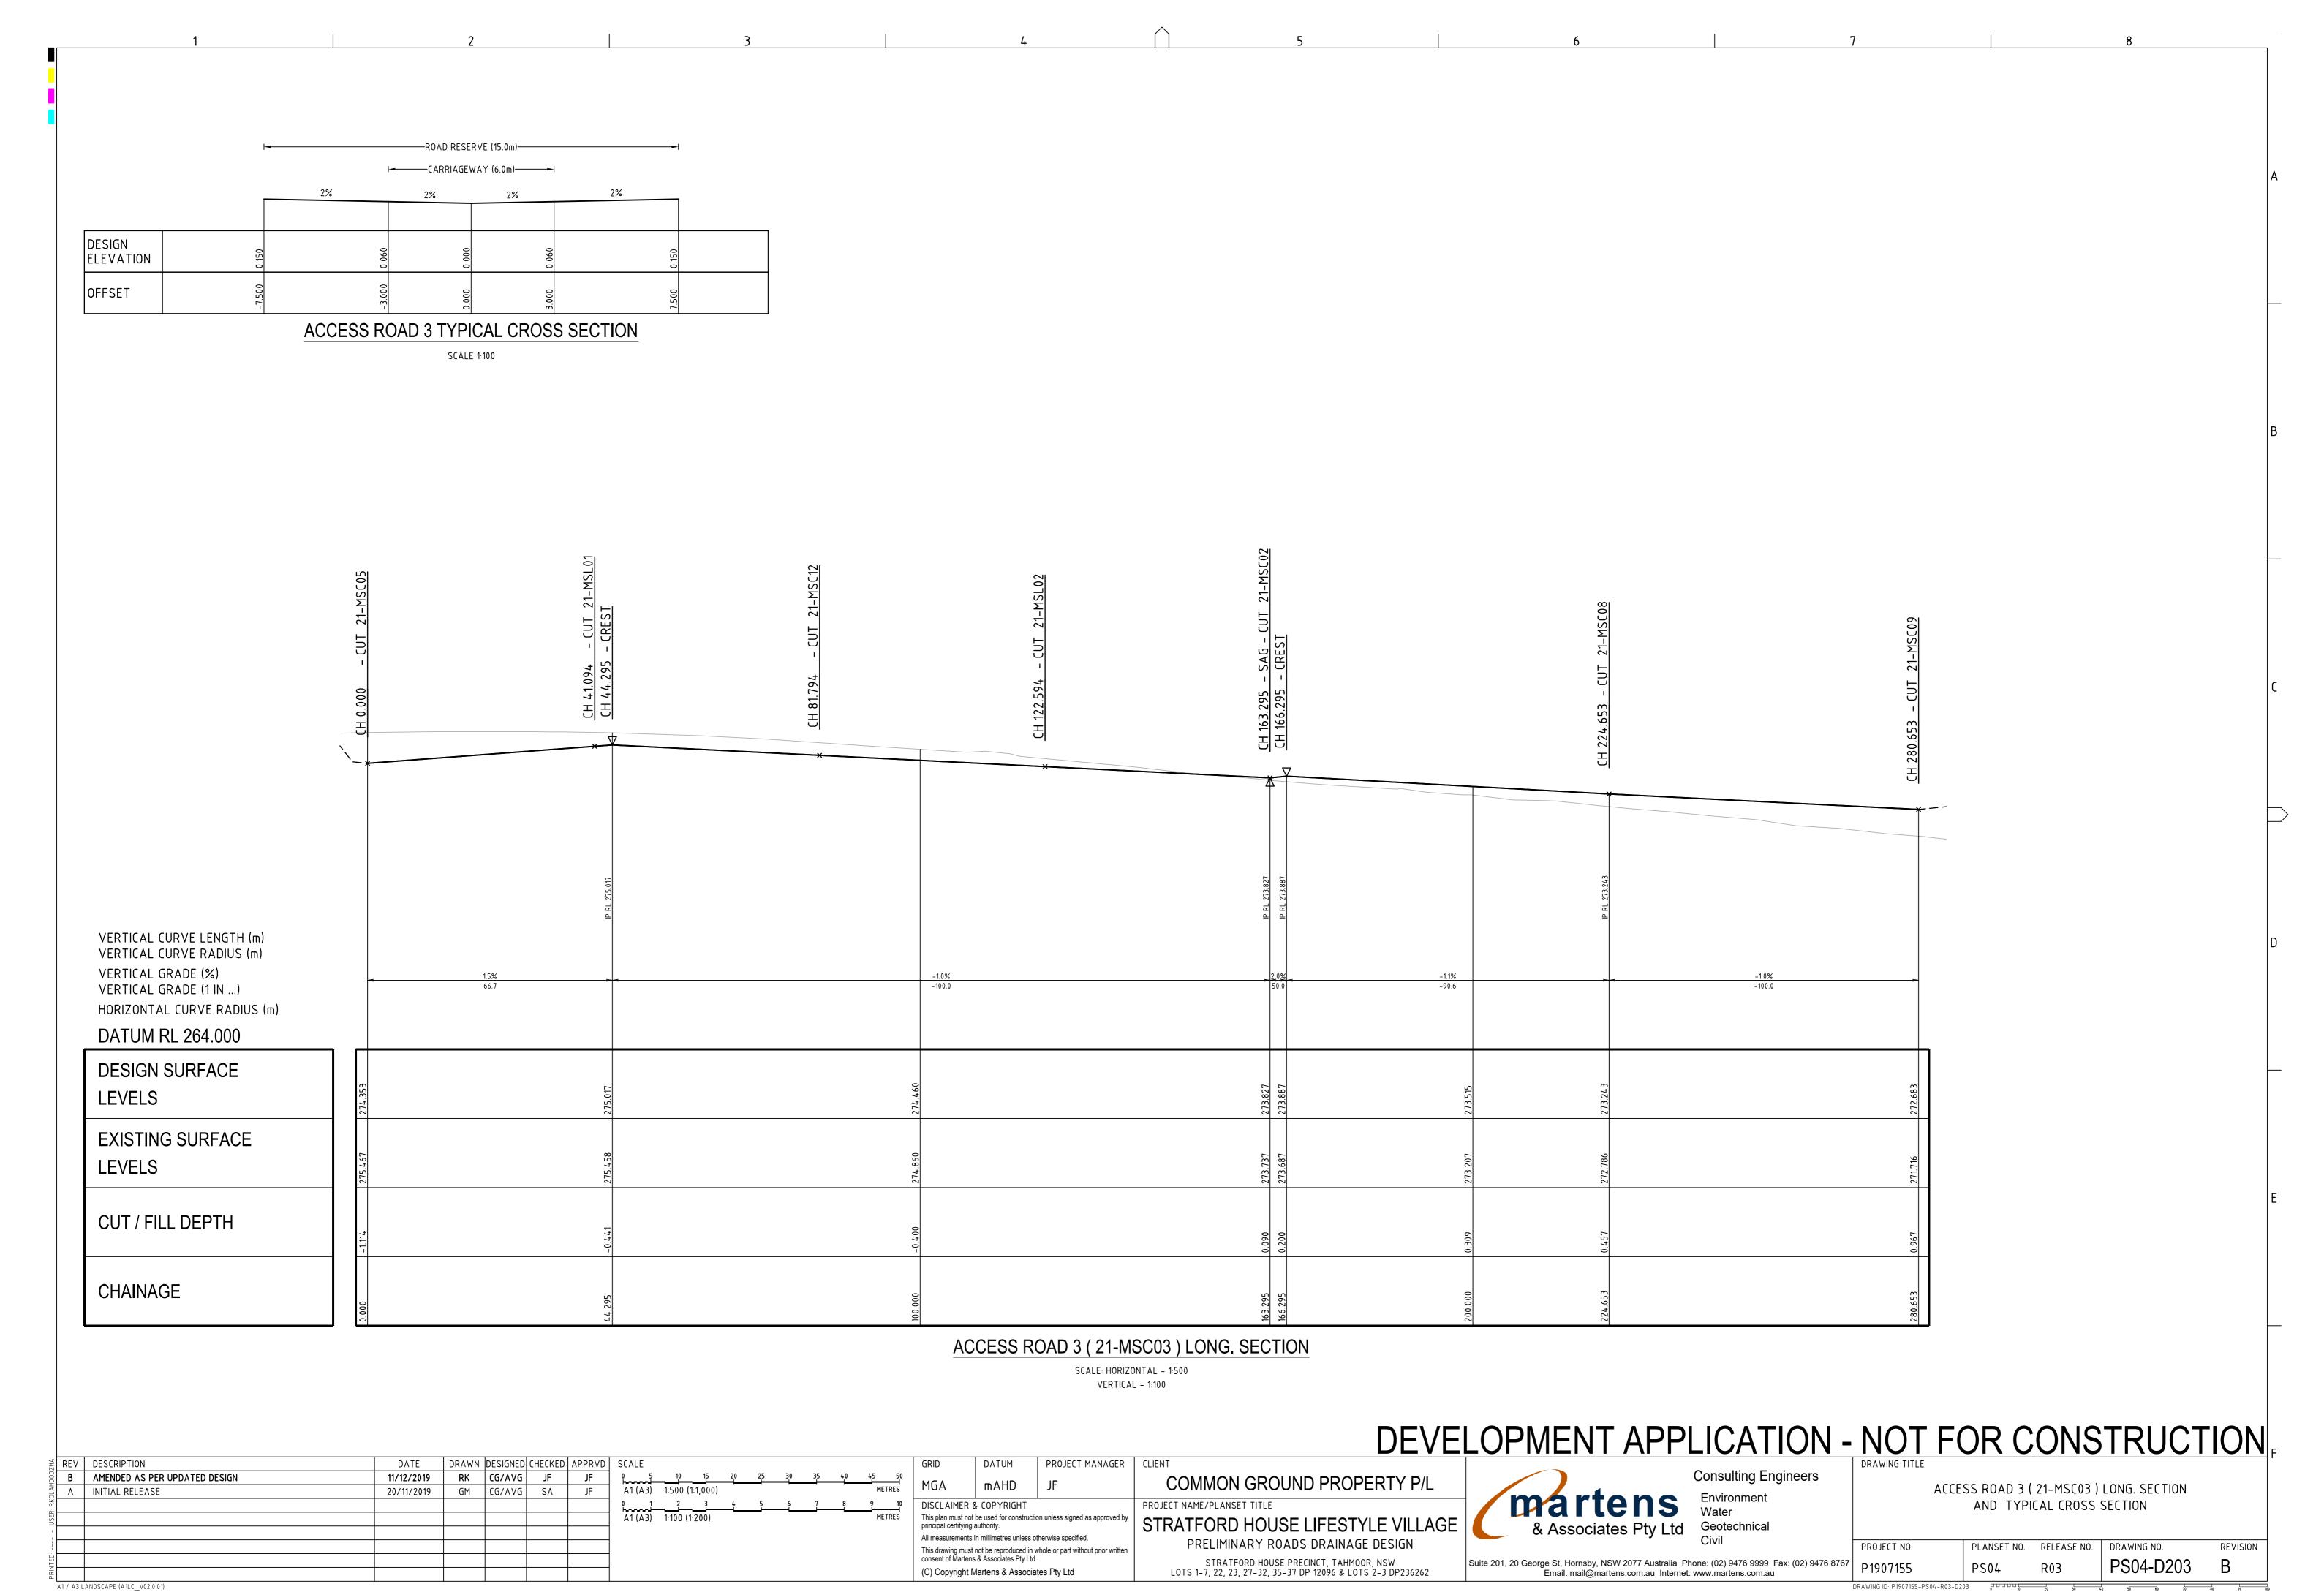

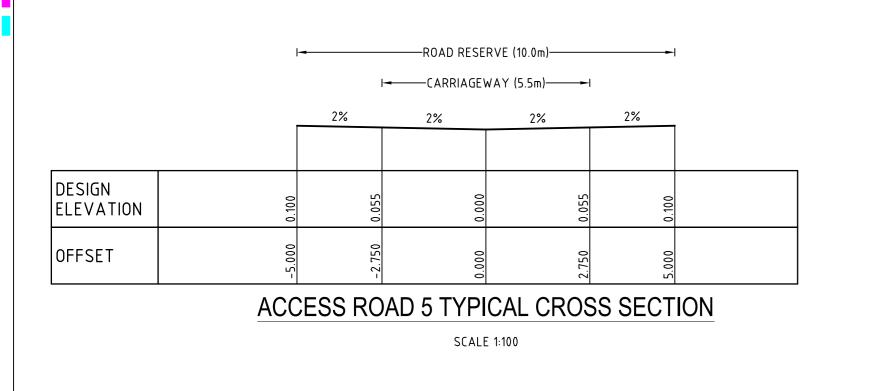

ACCESS ROAD 5 (21-MSC05) LONG. SECTION

SCALE: HORIZONTAL - 1:500 VERTICAL - 1:100

DEVELOPMENT APPLICATION - NOT FOR CONSTRUCTION -

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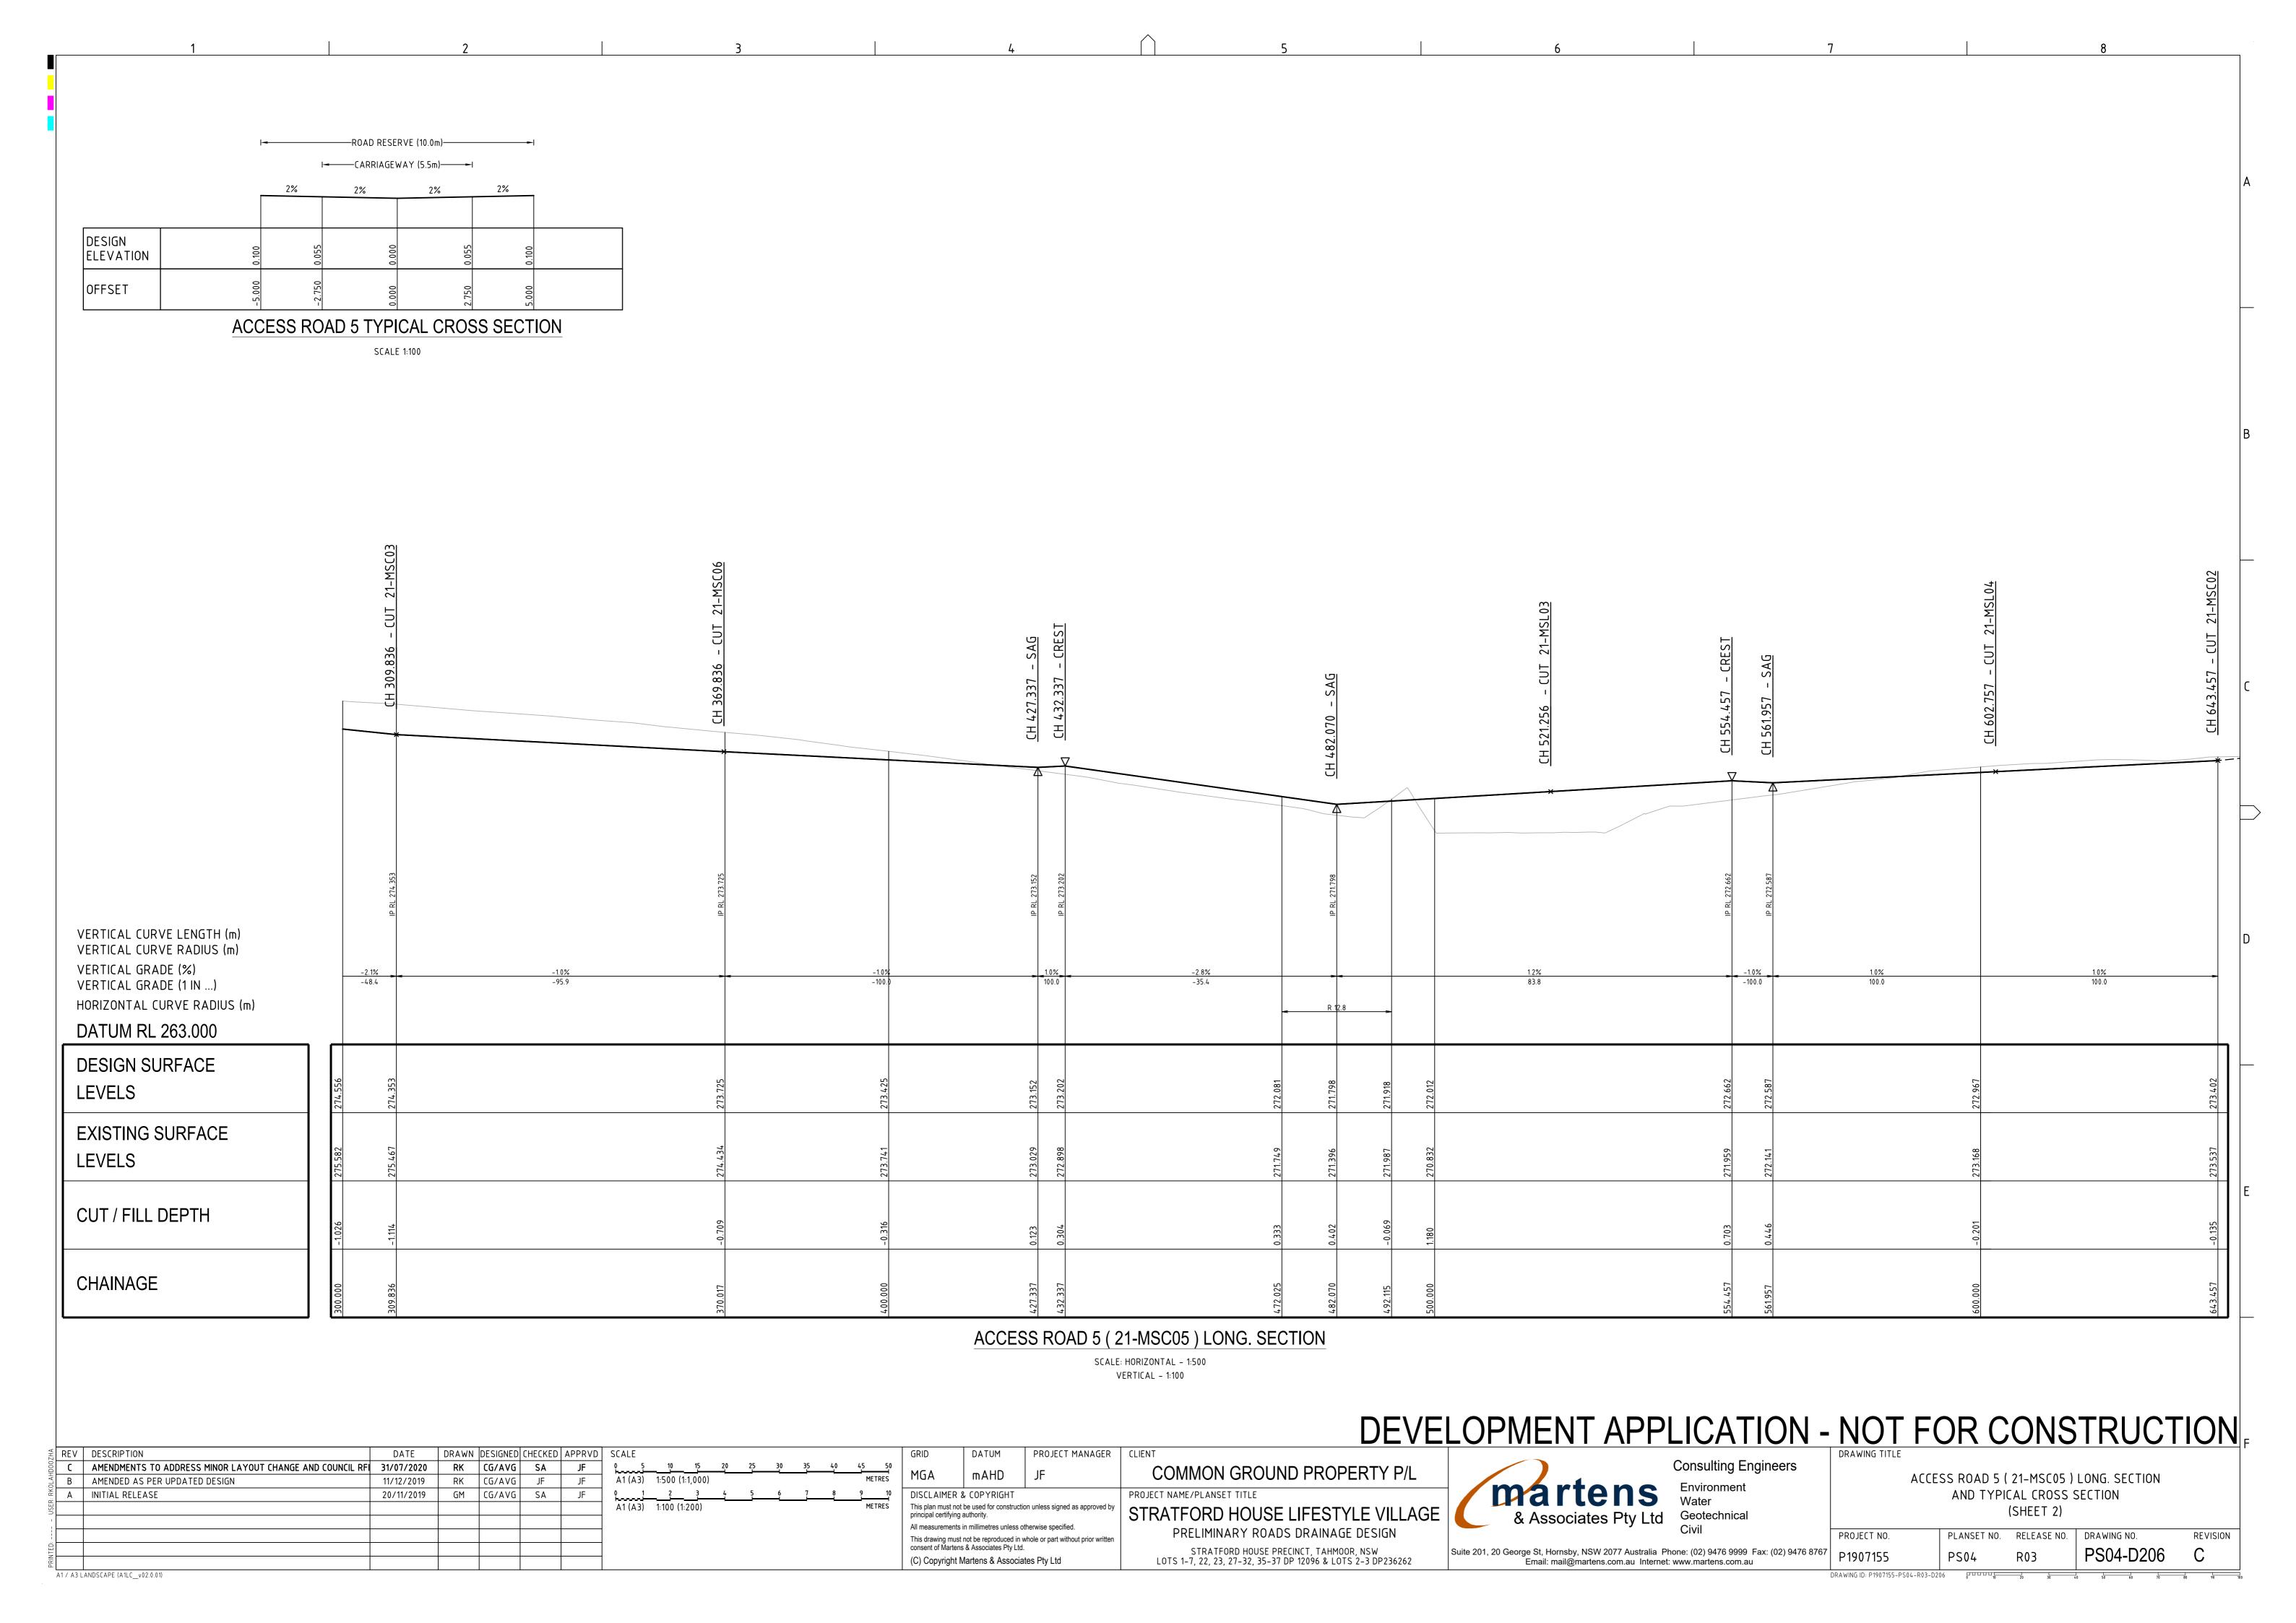
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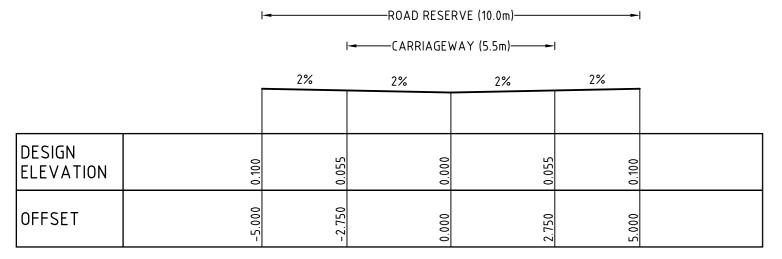
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ACCESS ROAD 5 (21-MSC05) LONG. SECTION
AND TYPICAL CROSS SECTION
(SHEET 1)


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1907155 PS04 R03 PS04-D205 C





ACCESS ROAD 6 TYPICAL CROSS SECTION

SCALE 1:100

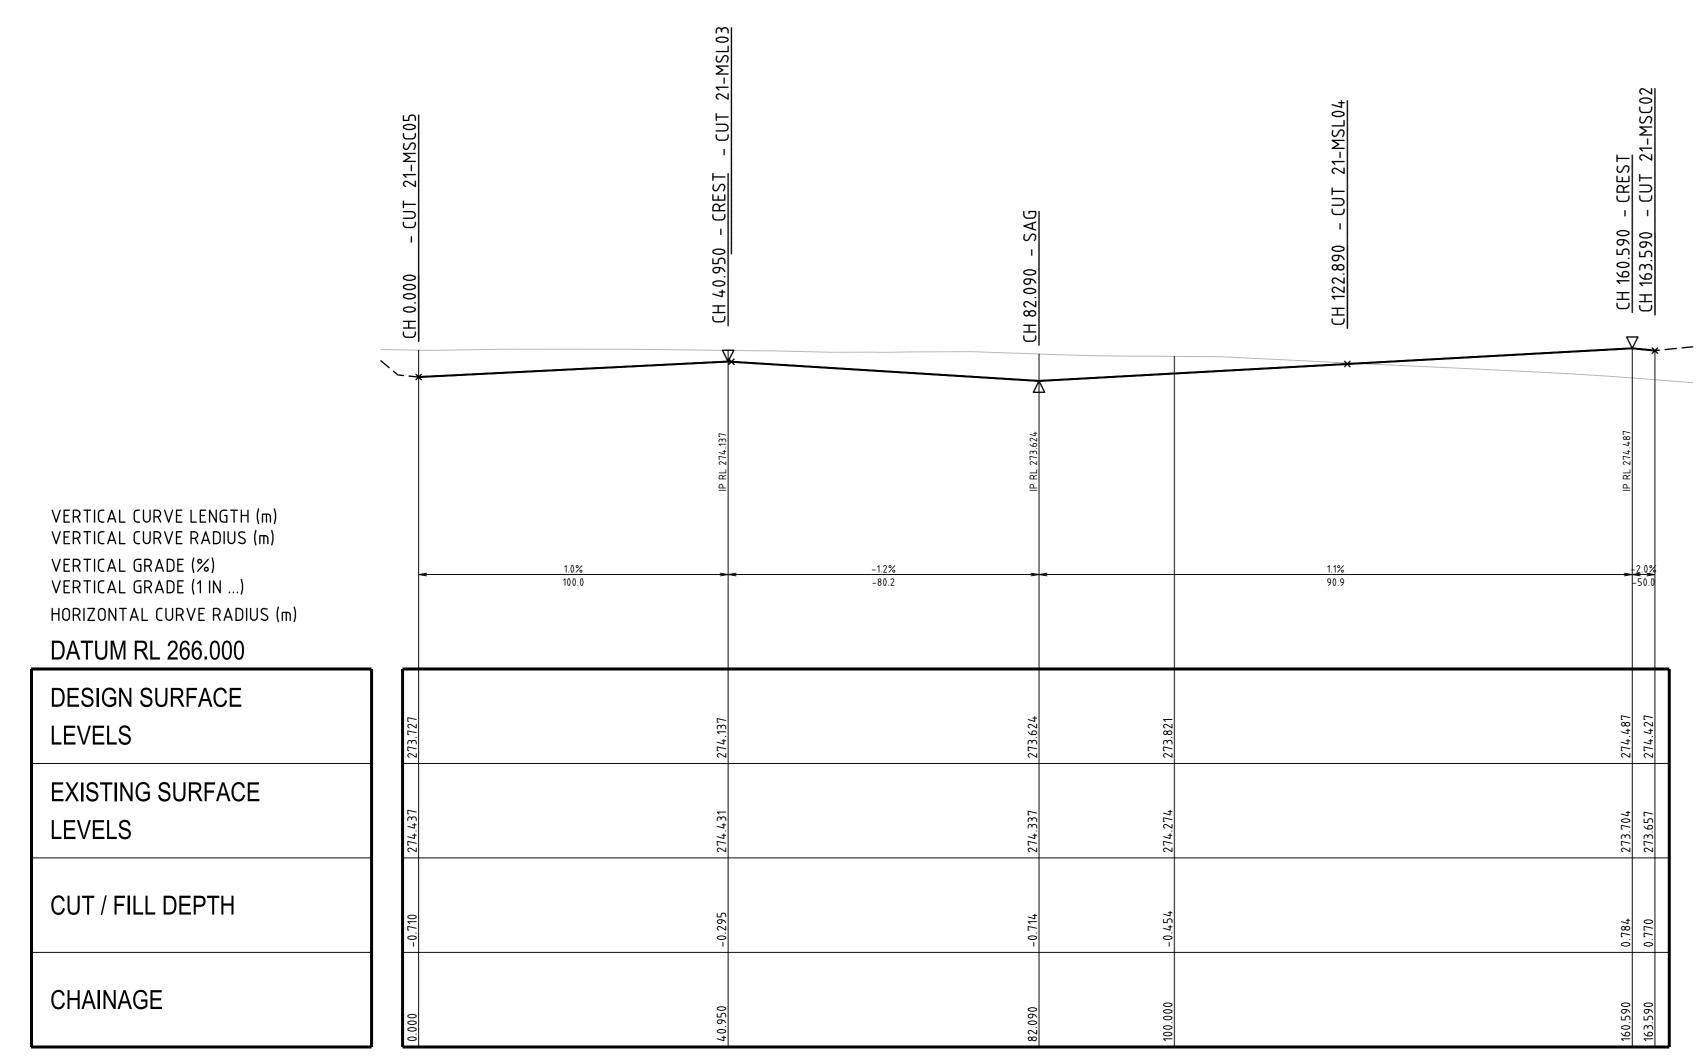

ACCESS ROAD 6 (21-MSC06) LONG. SECTION

SCALE: HORIZONTAL - 1:500 VERTICAL - 1:100


DEVE	LOPMENT	APPLICATION -	NOT FOR CONSTRUCTION
			DRAWING TITLE

₹REV	DESCRIPTION	DATE	DRAWN	DESIGNED	CHECKED	APPRVD	SCALE					GRID	DATUM	PROJECT MANAGER	CLIENT
B	AMENDED AS PER UPDATED DESIGN	11/12/2019	RK	CG/AVG	JF	JF	0 5 10 15 20	25 30	35	40	45 50	MGA	mAHD		COMMON GROUND PROPERTY P/L
A OF A	INITIAL RELEASE	20/11/2019	GM	CG/AVG	SA	JF	A1 (A3) 1:500 (1:1,000)				METRES	MUA	IIIAND) JF	COMMON GROUND FROI EIGHT 1/L
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A1 / A3	LANDSCAPE (A1LC_v02.0.01)		•	•		•	•					•			•

Consulting Engineers Environment


ACCESS ROAD 6 (21-MSC06) LONG. SECTION AND TYPICAL CROSS SECTION

PROJECT NO. PLANSET NO. RELEASE NO. DRAWING NO. REVISION Suite 201, 20 George St, Hornsby, NSW 2077 Australia Phone: (02) 9476 9999 Fax: (02) 9476 8767 Email: mail@martens.com.au Internet: www.martens.com.au PS04-D207

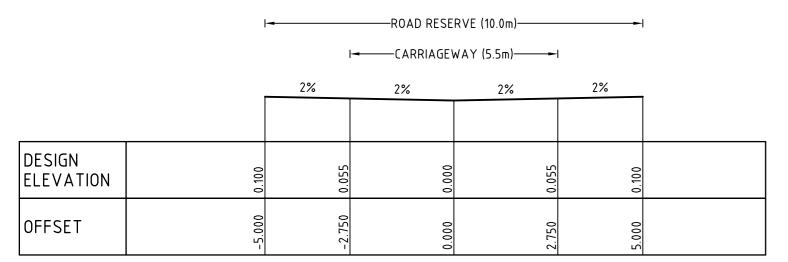


ACCESS ROAD 7 & 8 TYPICAL CROSS SECTION

SCALE 1:100

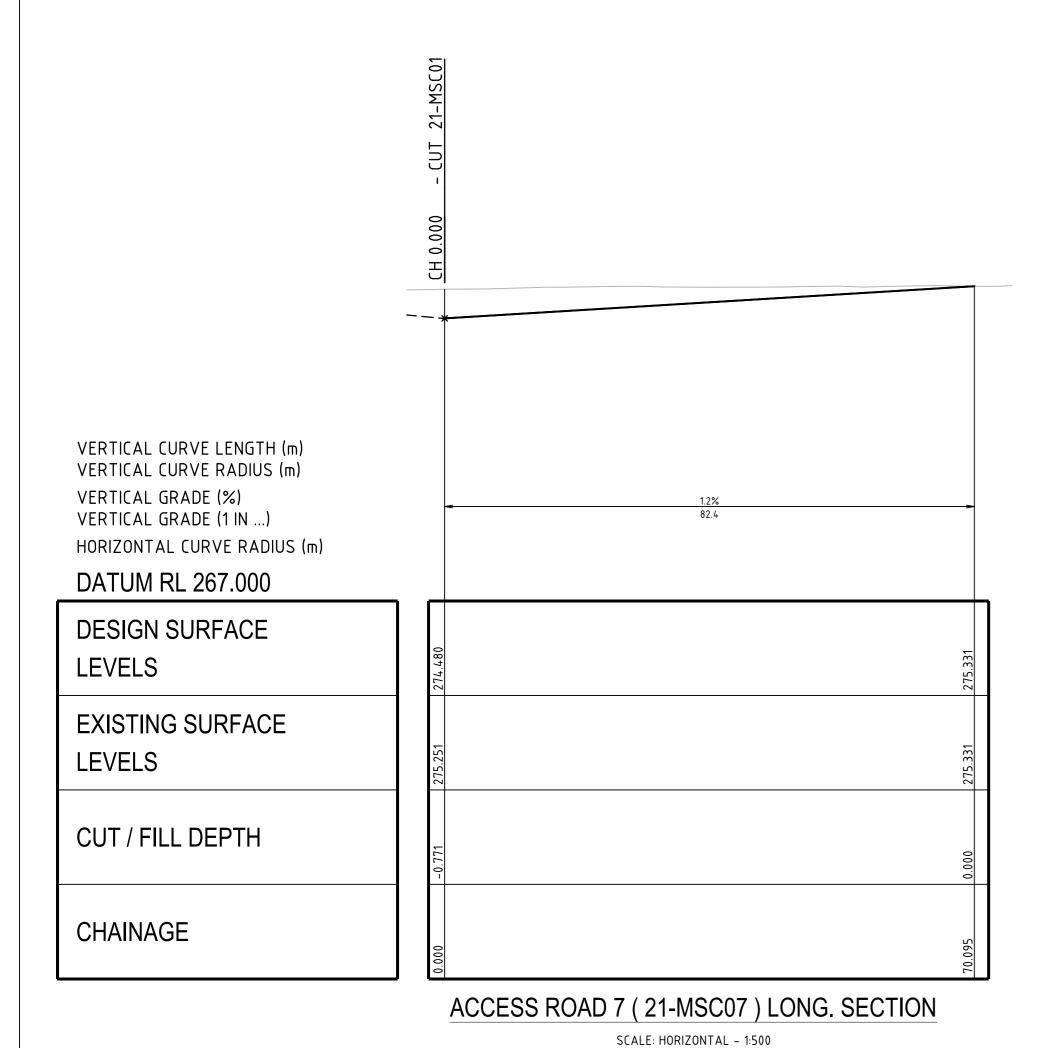

VERTICAL - 1:100

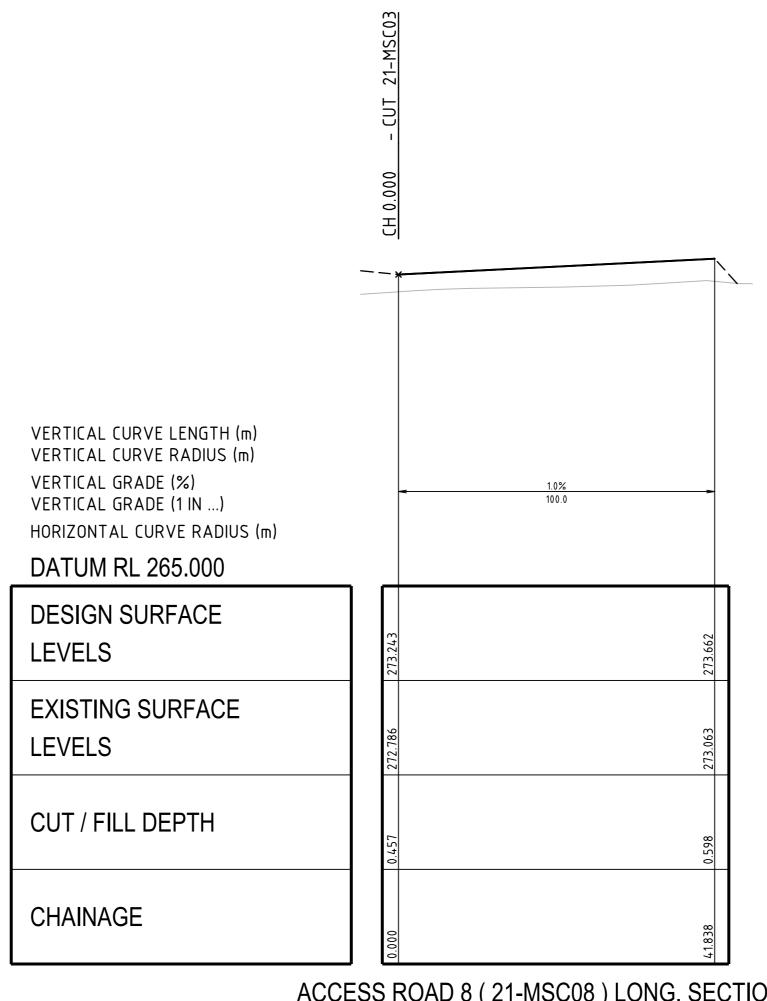

ACCESS ROAD 8 (21-MSC08) LONG. SECTION

SCALE: HORIZONTAL - 1:500 VERTICAL - 1:100


DEVELOPMENT APPLICATION - NOT FOR CONSTRUCTION


∄ REV	DESCRIPTION	DATE	DRAWN	DESIGNED	CHECKED	APPRVD	SCALE	GRID	DATUM	PROJECT MANAGER	CLIENT
о _ф с	AMENDMENTS TO ADDRESS MINOR LAYOUT CHANGE AND COUNCIL RFI	31/07/2020	RK	CG/AVG	SA	JF	0 5 10 15 20 25 30 35 40 45 50	MGA	mAHD		COMMON GROUND PROPERTY P/L
B B	AMENDED AS PER UPDATED DESIGN	11/12/2019	RK	CG/AVG	JF	JF	A1 (A3) 1:500 (1:1,000) METRES	ADM	IIIAND) JF	COMMON ONCOME I NOI LINI I /L
χ. A	INITIAL RELEASE	20/11/2019	GM	CG/AVG	SA	JF	0 1 2 3 4 5 6 7 8 9 10	DISCLAIMER	& COPYRIGHT		PROJECT NAME/PLANSET TITLE
USEF							A1 (A3) 1:100 (1:200) METRES	This plan must no principal certifying		ion unless signed as approved by	STRATFORD HOUSE LIFESTYLE VILLAGE
1								1 , ,	s in millimetres unless of	otherwise specified.	
								1		whole or part without prior written	PRELIMINARY ROADS DRAINAGE DESIGN
ÜED									is & Associates Pty Ltd		STRATFORD HOUSE PRECINCT, TAHMOOR, NSW
PRIN								(C) Copyright	Martens & Associa	ates Pty Ltd	LOTS 1-7, 22, 23, 27-32, 35-37 DP 12096 & LOTS 2-3 DP236262
A1 / A3	LANDSCAPE (A1LC_v02.0.01)	•	•	'			•	•			

Consulting Engineers martens & Associates Pty Ltd

ACCESS ROAD 7 (21-MSC07) & 8 (21-MSC08) LONG. SECTIONS AND TYPICAL CROSS SECTION PLANSET NO. RELEASE NO. DRAWING NO. REVISION


Suite 201, 20 George St, Hornsby, NSW 2077 Australia Phone: (02) 9476 9999 Fax: (02) 9476 8767 Email: mail@martens.com.au Internet: www.martens.com.au PS04-D208 DRAWING ID: P1907155-PS04-R03-D208

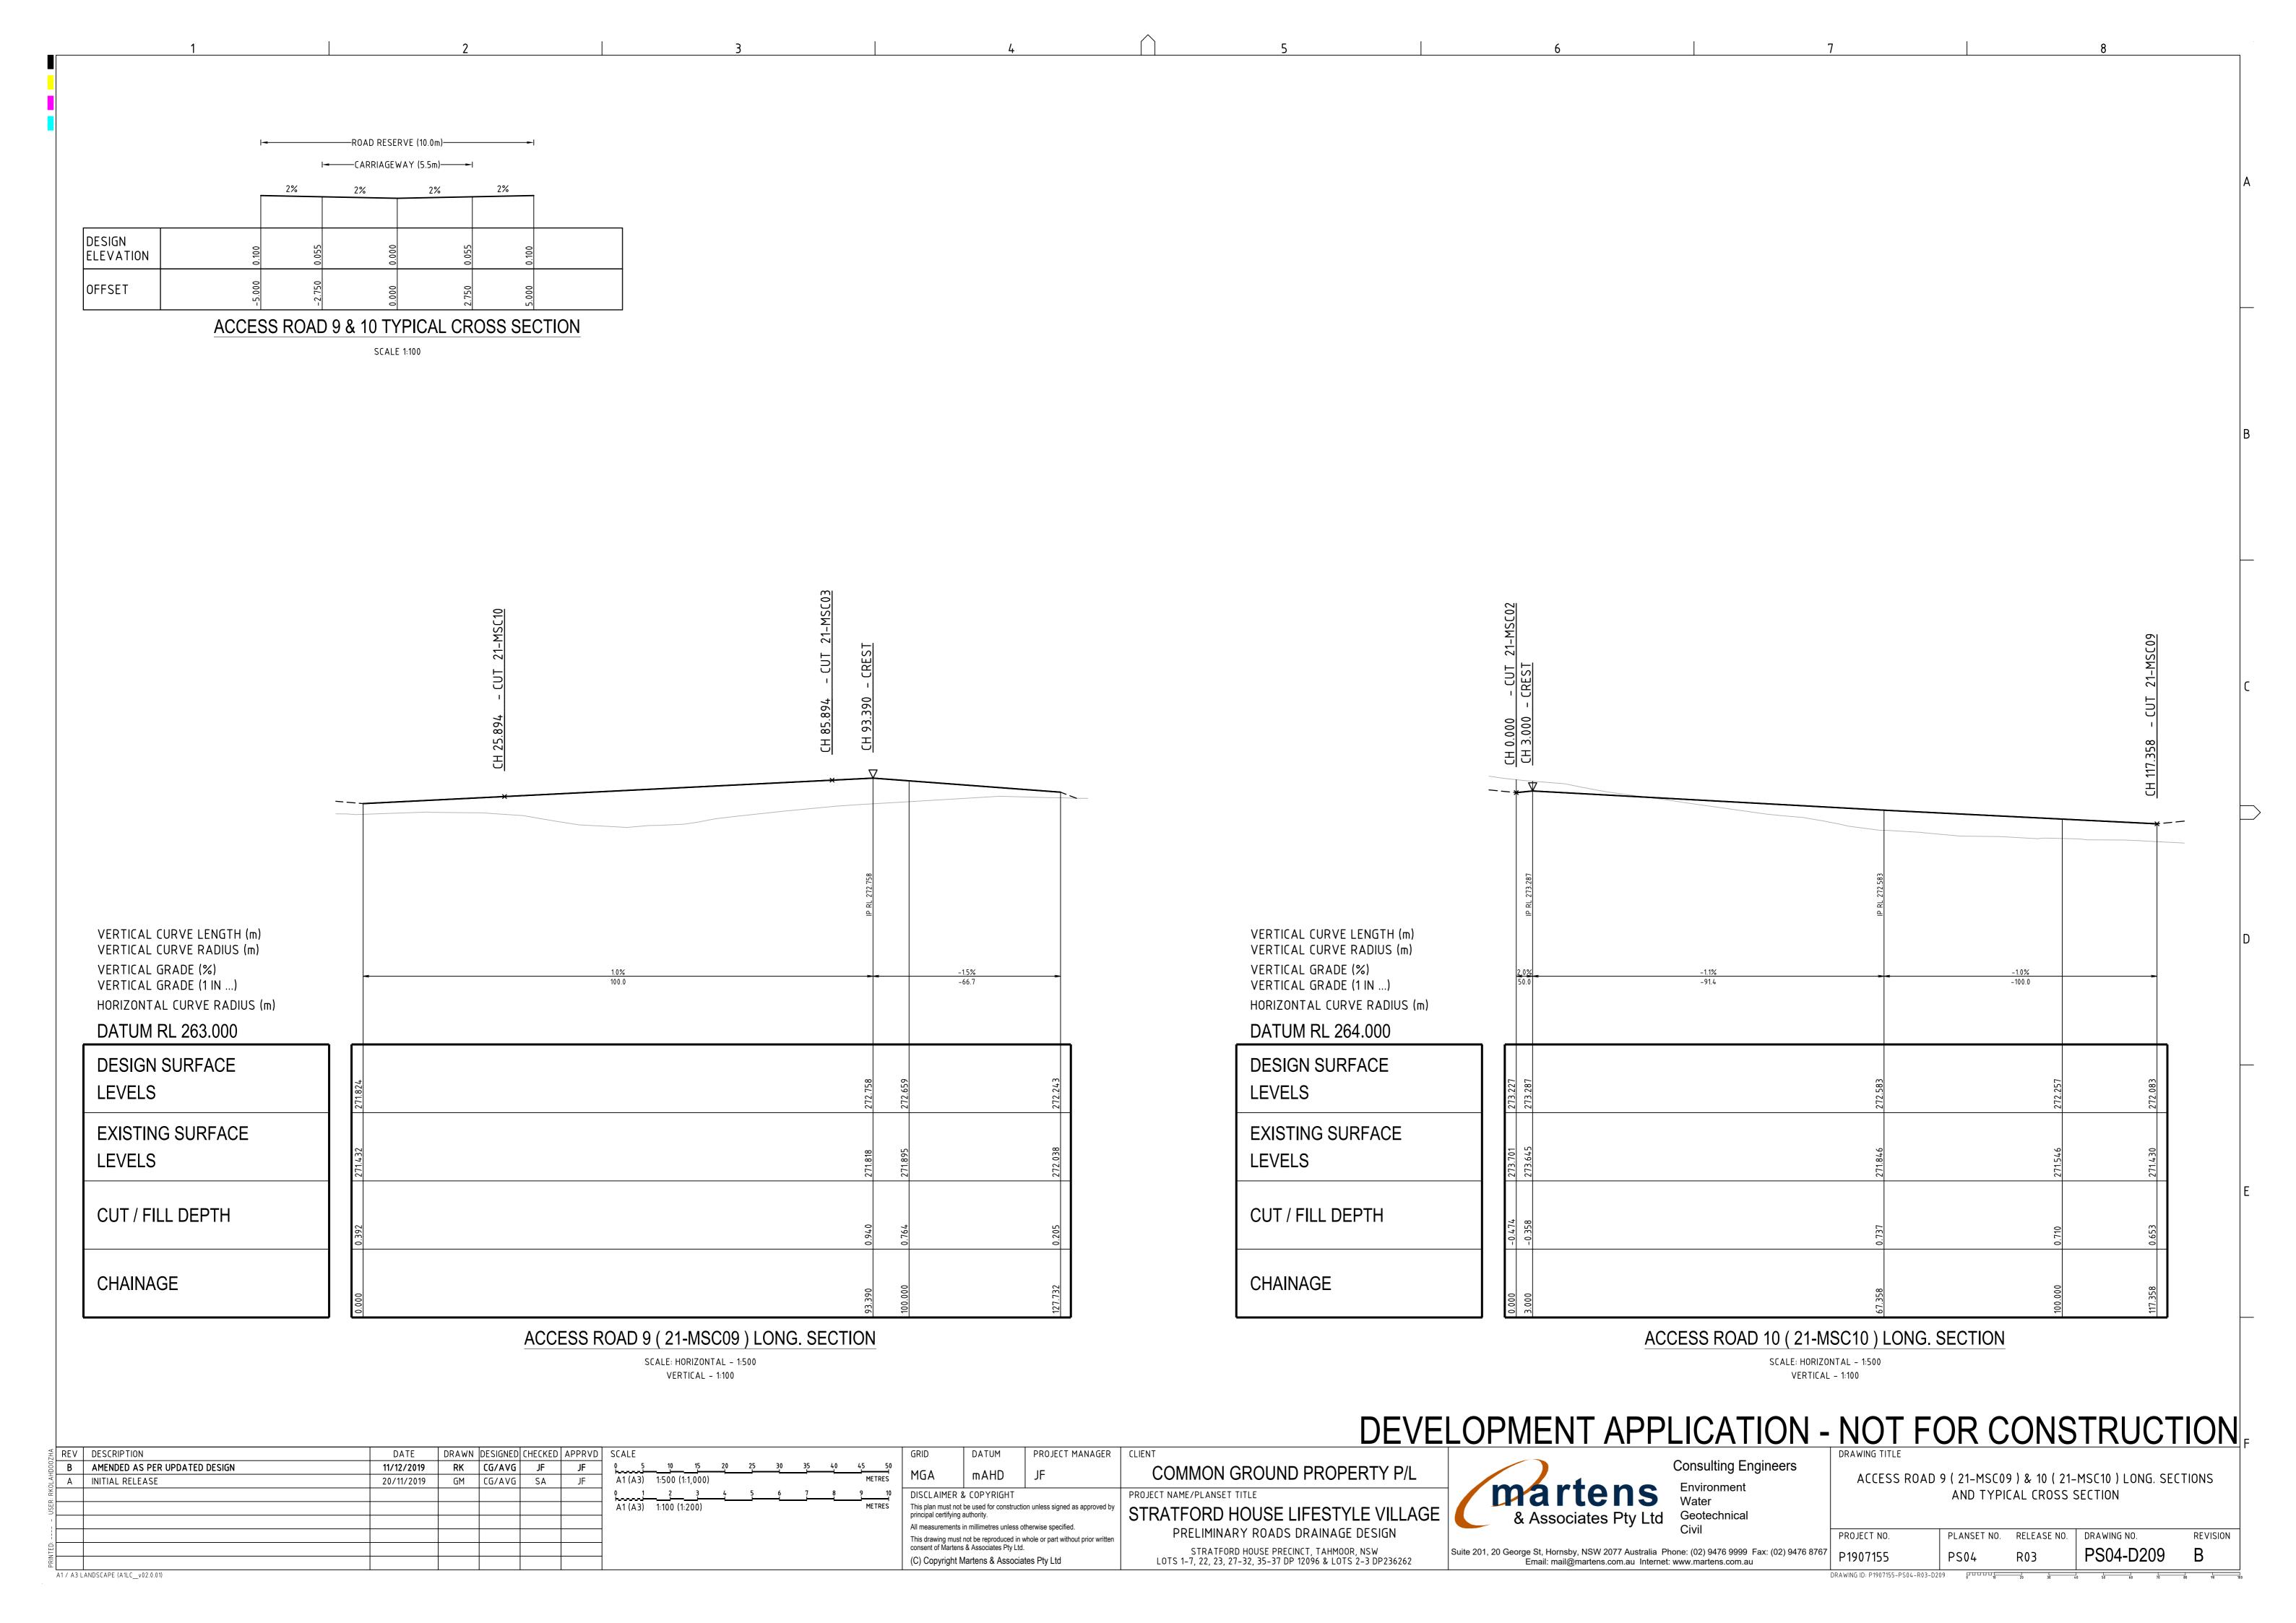

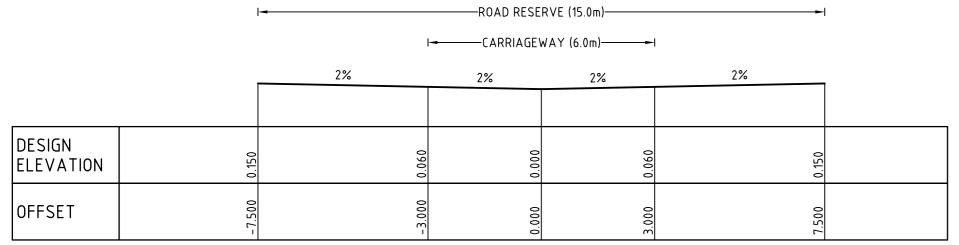

ACCESS ROAD 12 TYPICAL CROSS SECTION

SCALE 1:100

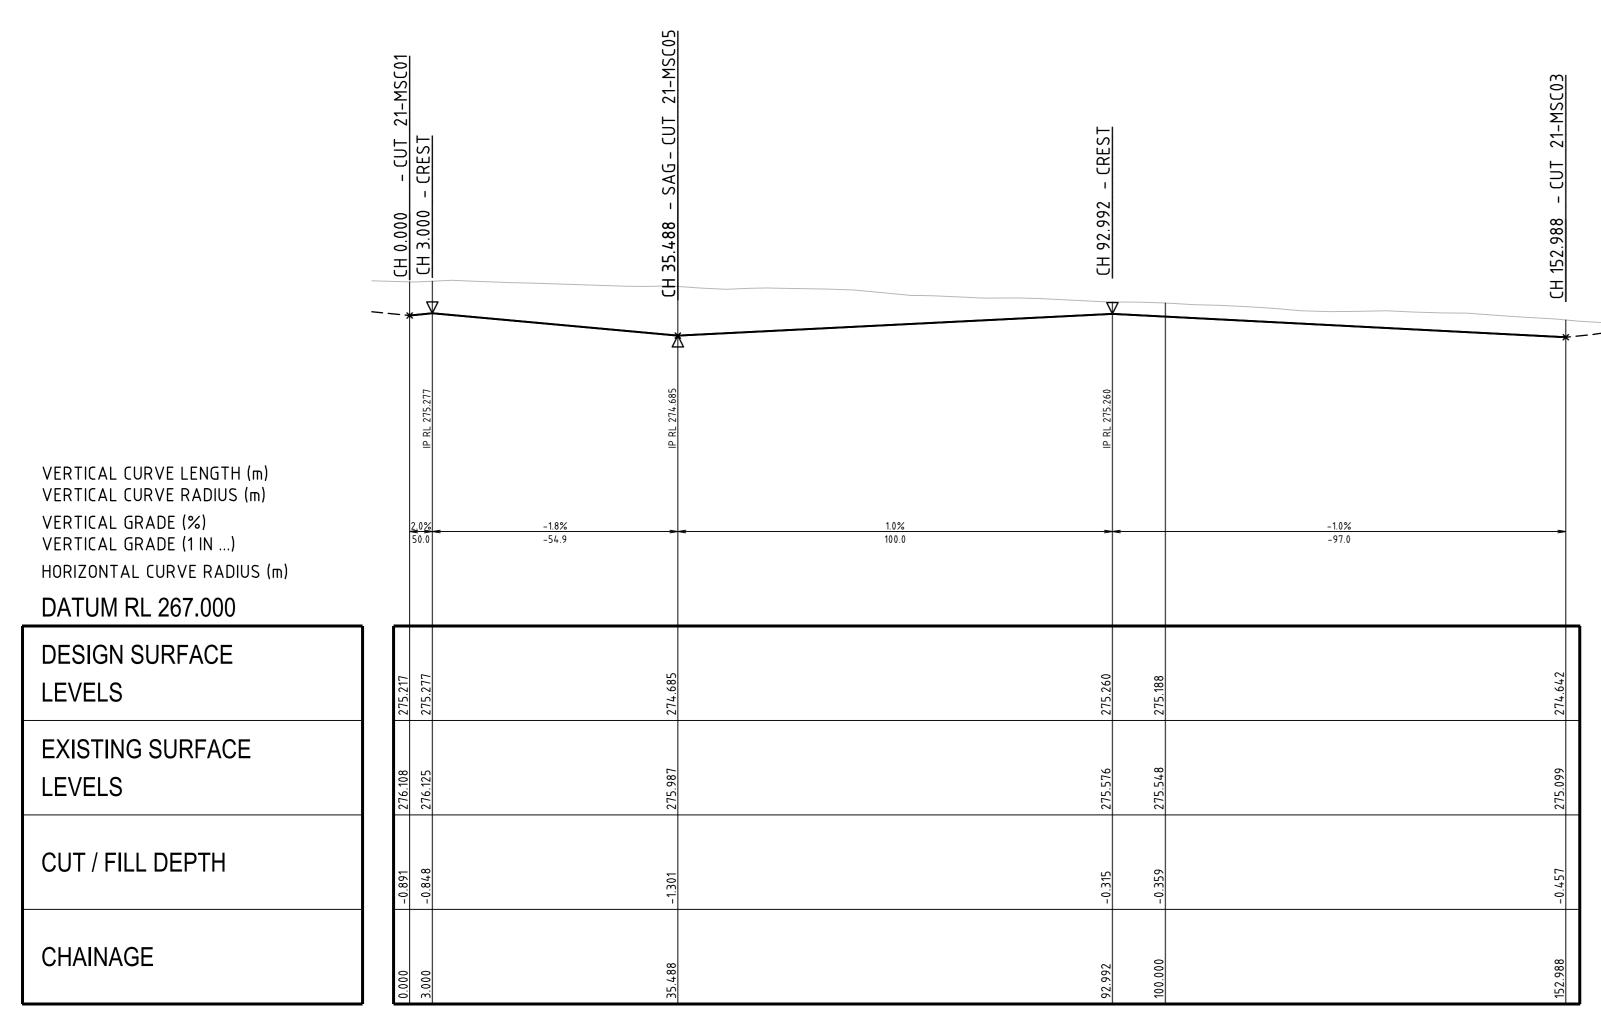

ACCESS ROAD 12 (21-MSC12) LONG. SECTION

SCALE: HORIZONTAL - 1:500 VERTICAL - 1:100

DEVELOPMENT APPLICATION - NOT FOR CONSTRUCTION -

₹ REV	DESCRIPTION	DATE	DRAWN	DESIGNED	CHECKED	APPRVD	SCALE	GRID	DATUM	PROJECT MANAGER	CLIENT
о́ д В	AMENDED AS PER UPDATED DESIGN	11/12/2019	RK	CG/AVG	JF	JF	0 5 10 15 20 25 30 35 40 45 5	MGA	mAHD		COMMON GROUND PROPERTY P/L
A S	INITIAL RELEASE	20/11/2019	GM	CG/AVG	SA	JF	A1 (A3) 1:500 (1:1,000) METRES	MUA	IIIAND) JF	COMMON GROUND FROM LIVER 17L
¥							0 1 2 3 4 5 6 7 8 9 1	I	ER & COPYRIGHT		PROJECT NAME/PLANSET TITLE
USE							A1 (A3) 1:100 (1:200) METRES	This plan mus principal certi		ction unless signed as approved by	STRATFORD HOUSE LIFESTYLE VILLAGE
1								1 ' '	ents in millimetres unles	s otherwise specified	
								1		n whole or part without prior written	PRELIMINARY ROADS DRAINAGE DESIGN
TED:									rtens & Associates Pty L		STRATFORD HOUSE PRECINCT, TAHMOOR, NSW
PRIN								(C) Copyri	ht Martens & Assoc	ciates Pty Ltd	LOTS 1-7, 22, 23, 27-32, 35-37 DP 12096 & LOTS 2-3 DP236262
A1 / A3	LANDSCAPE (A1LC_v02.0.01)		1	1		1					1

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	/martens	E V
-	& Associates Pty Ltd	

Consulting Engineers
Environment
Water
Geotechnical
Civil

ACCESS ROAD 12 (21-MSC12) LONG. SECTION

AND TYPICAL CROSS SECTION


Civil


PROJECT NO.


PLANSET NO. RELEASE NO. DRAWING NO.

REVISION

Production of the production of the

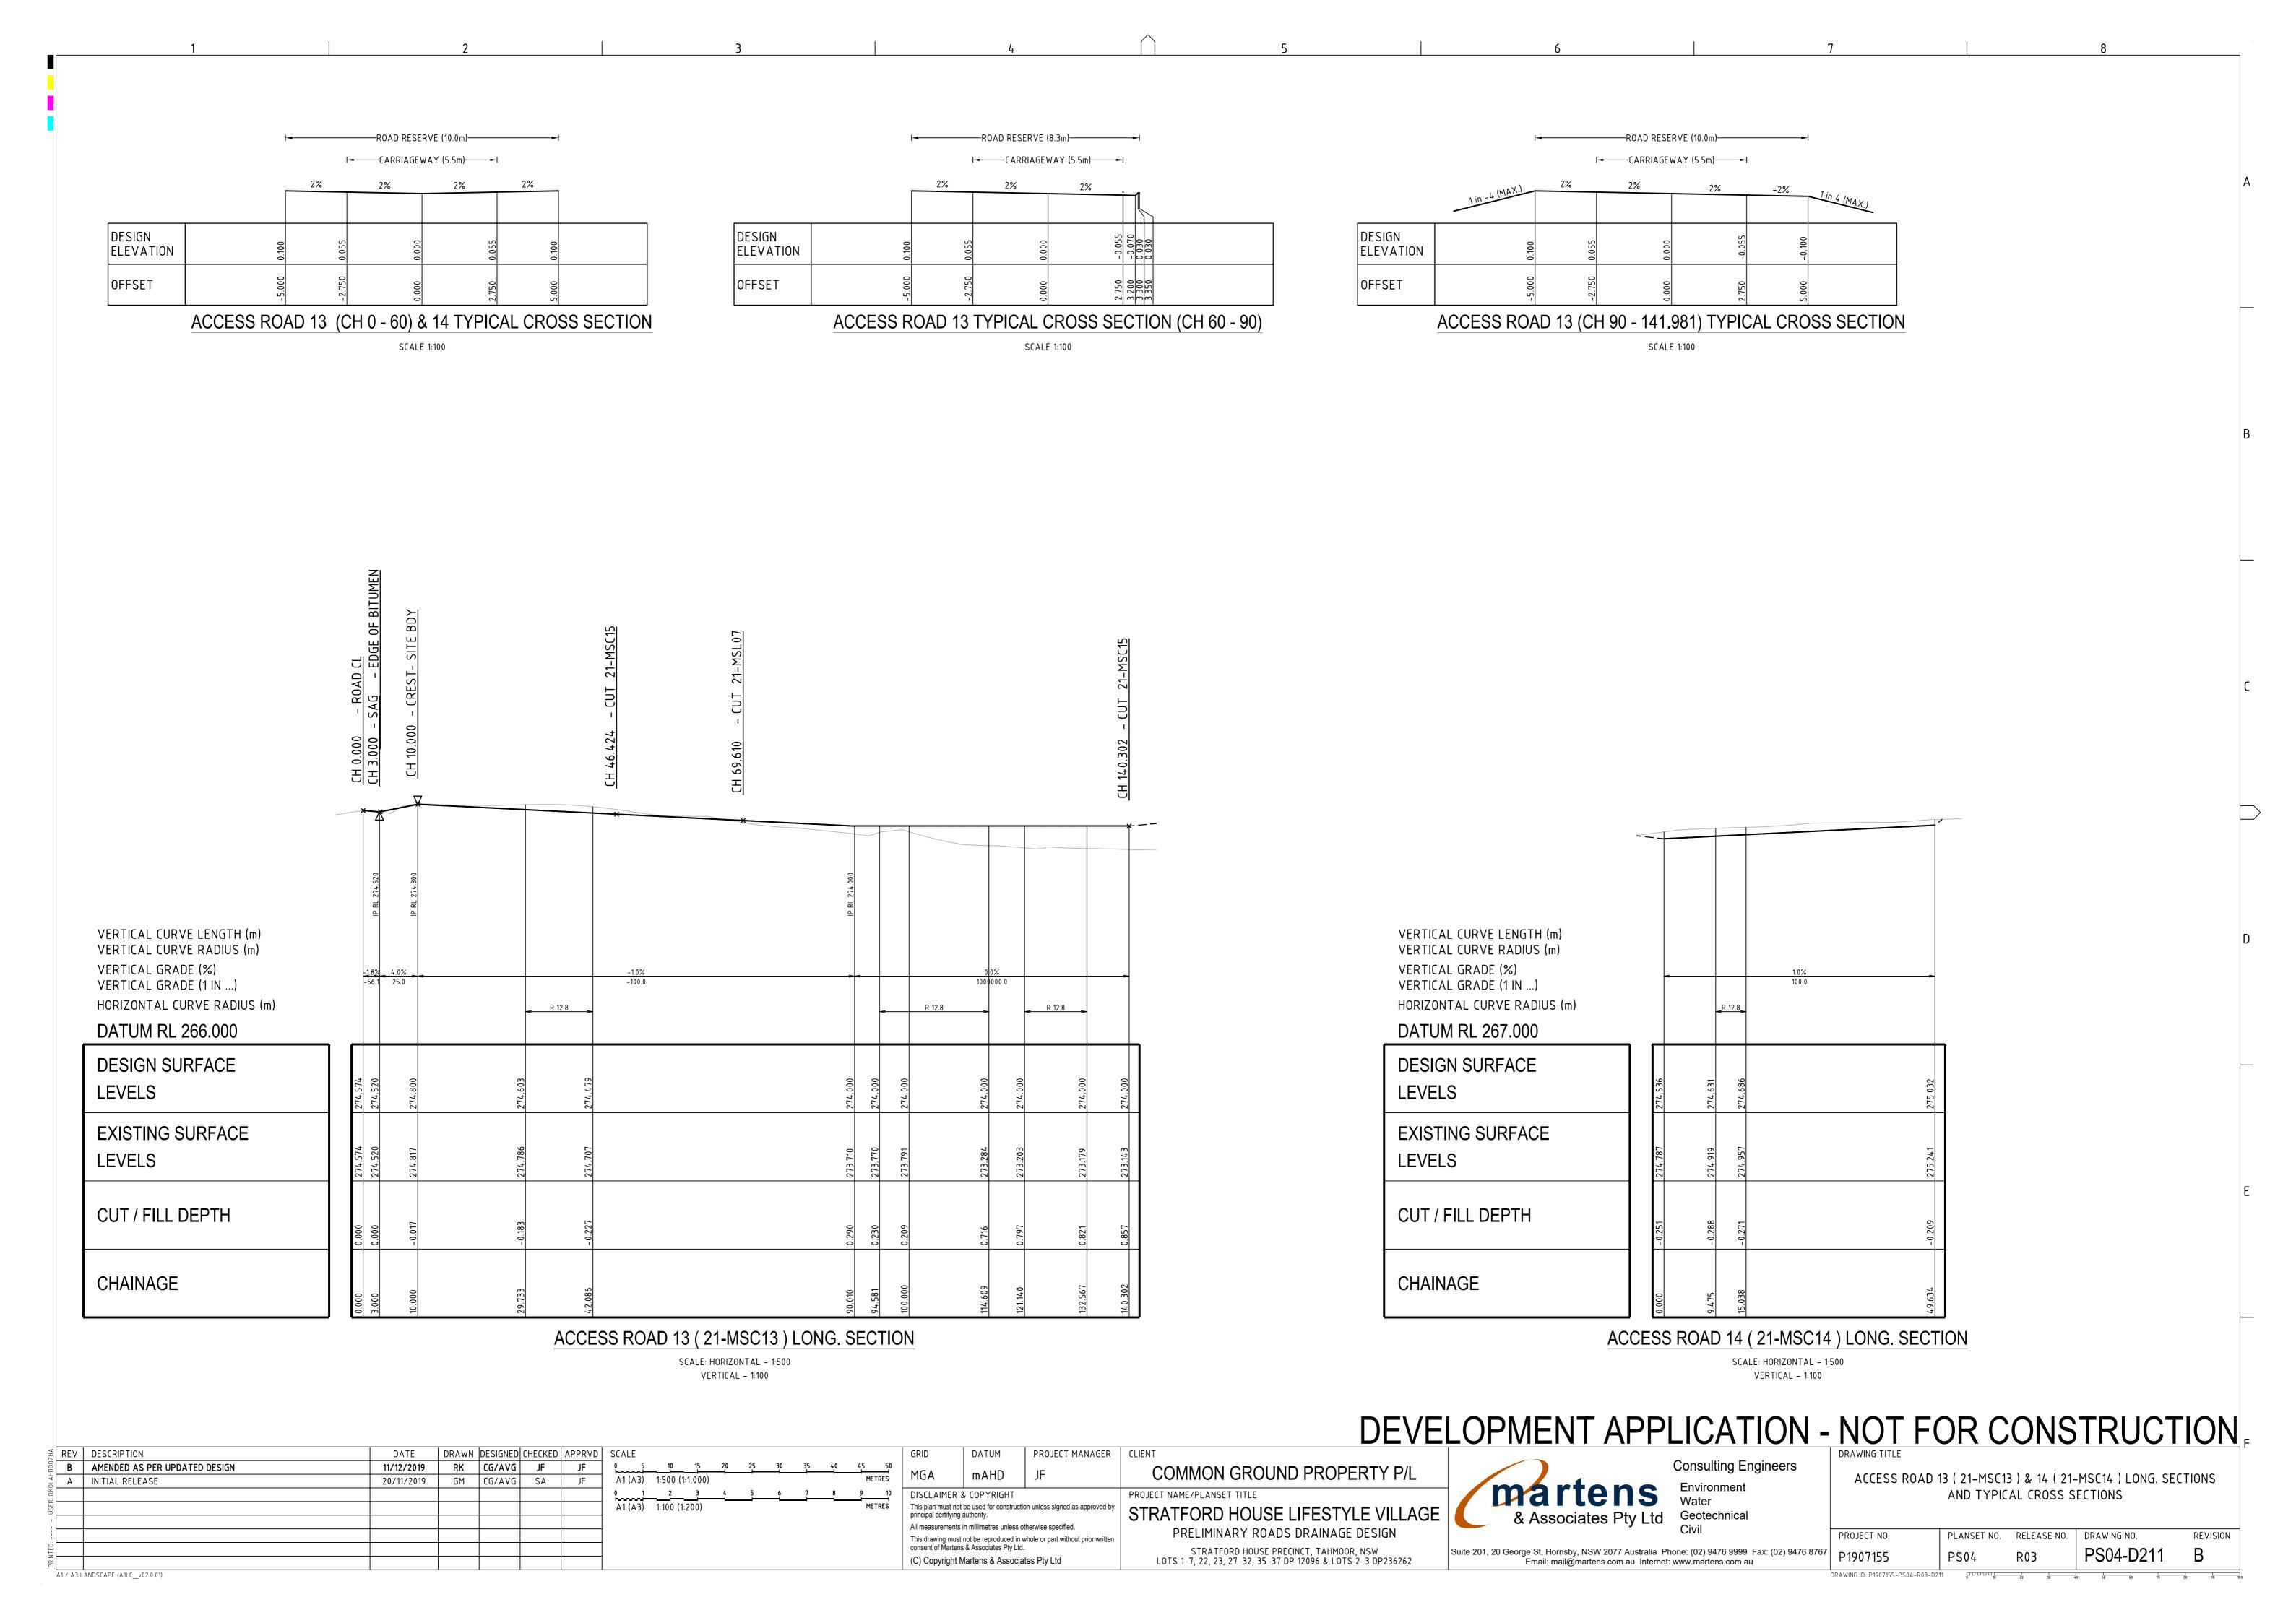

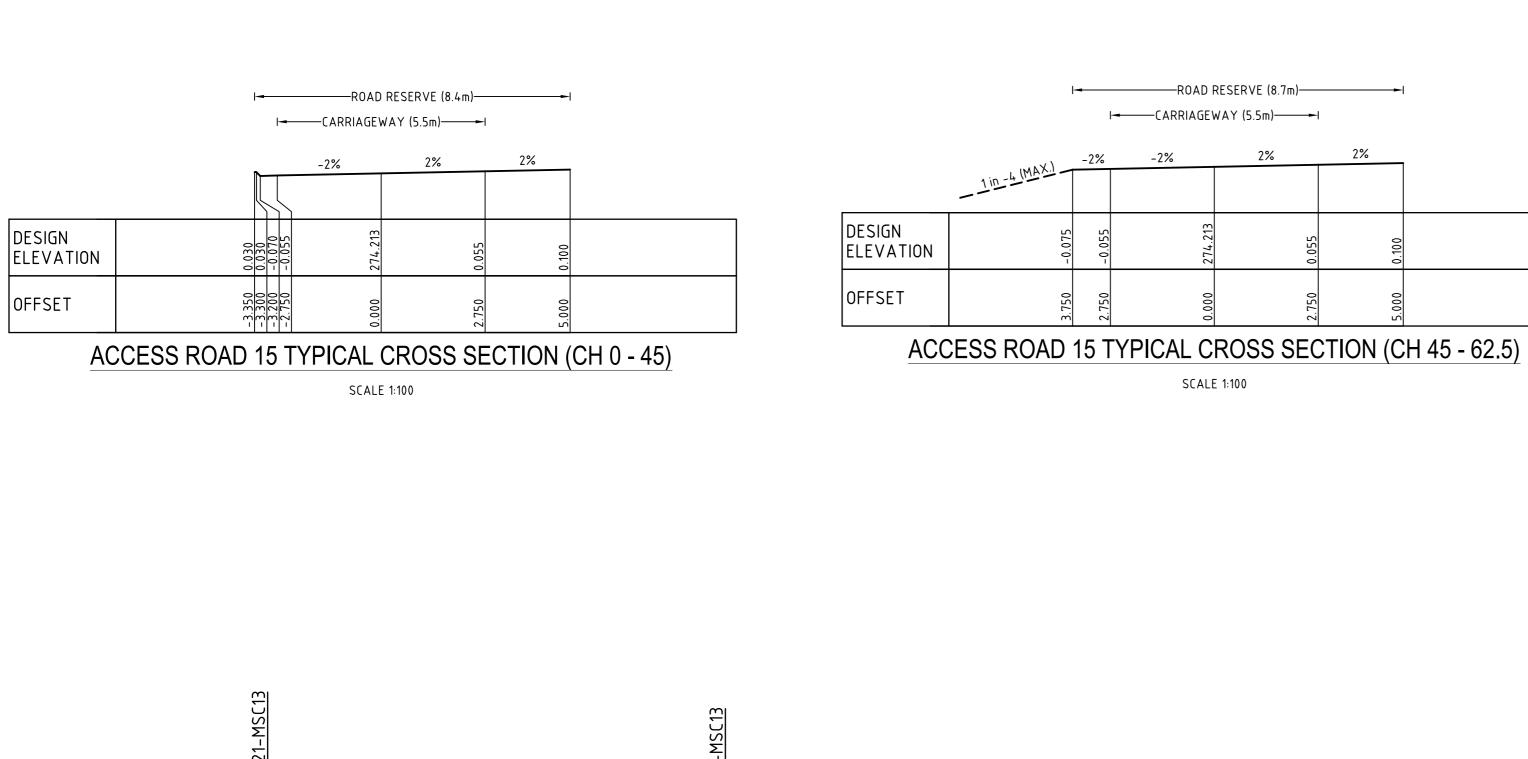

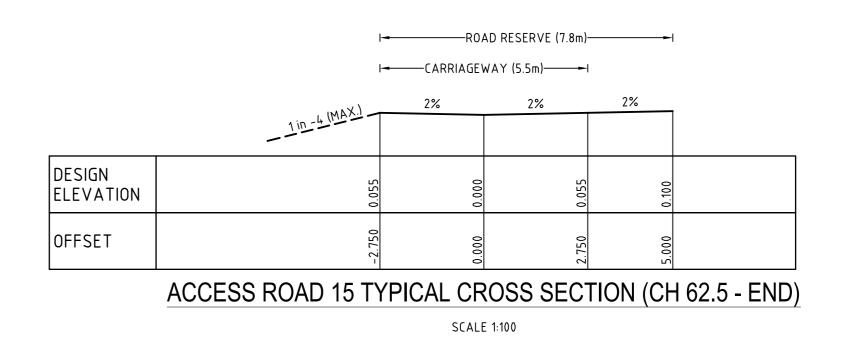

VERTICAL CURVE LENGTH (m)
VERTICAL CURVE RADIUS (m)
VERTICAL CURVE RADIUS (m)
VERTICAL CURVE RADIUS (m)
VERTICAL CURVE RADIUS (m)
DATUM RL 265.000

DESIGN SURFACE
LEVELS

EXISTING SURFACE
LEVELS

CUT / FILL DEPTH

CHAINAGE

ACCESS ROAD 15 (21-MSC15) LONG. SECTION

SCALE: HORIZONTAL - 1:500 VERTICAL - 1:100

DEVELOPMENT APPLICATION - NOT FOR CONSTRUCTION

₹ REV	DESCRIPTION	DATE	DRAWN	DESIGNED	CHECKED	APPRVD	SCALE	GRID	DATUM	PROJECT MANAGER	CLIENT
оод В	AMENDED AS PER UPDATED DESIGN	11/12/2019	RK	CG/AVG	JF	JF	0 5 10 15 20 25 30 35 40 45 50	MGA	mAHD	IE	COMMON GROUND PROPERTY P/L
A OLA	INITIAL RELEASE	20/11/2019	GM	CG/AVG	SA	JF	A1 (A3) 1:500 (1:1,000) METRES	MUA	ШАПО	JF	COMMON GROUND FROI LIVEFF
RK							0 1 2 3 4 5 6 7 8 9 10	DISCLAIMER &	COPYRIGHT		PROJECT NAME/PLANSET TITLE
USEF								This plan must not be principal certifying a		on unless signed as approved by	STRATFORD HOUSE LIFESTYLE VILLAGE
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									n millimetres unless of	·	PRELIMINARY ROADS DRAINAGE DESIGN
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PRIN								(C) Copyright M	lartens & Associa	tes Pty Ltd	LOTS 1-7, 22, 23, 27-32, 35-37 DP 12096 & LOTS 2-3 DP236262
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Martens Env War & Associates Pty Ltd Geo

Consulting Engineers
Environment
Water
Geotechnical
Civil

ACCESS ROAD 15 (21-MSC15) LONGITUDINAL SECTION
AND TYPICAL CROSS SECTION

Civil

PROJECT NO.

PLANSET NO. RELEASE NO.


DRAWING NO.


REVISION

PS04 R03

PS04-D212


BRAWING ID: P1907155-PS04-R03-D212

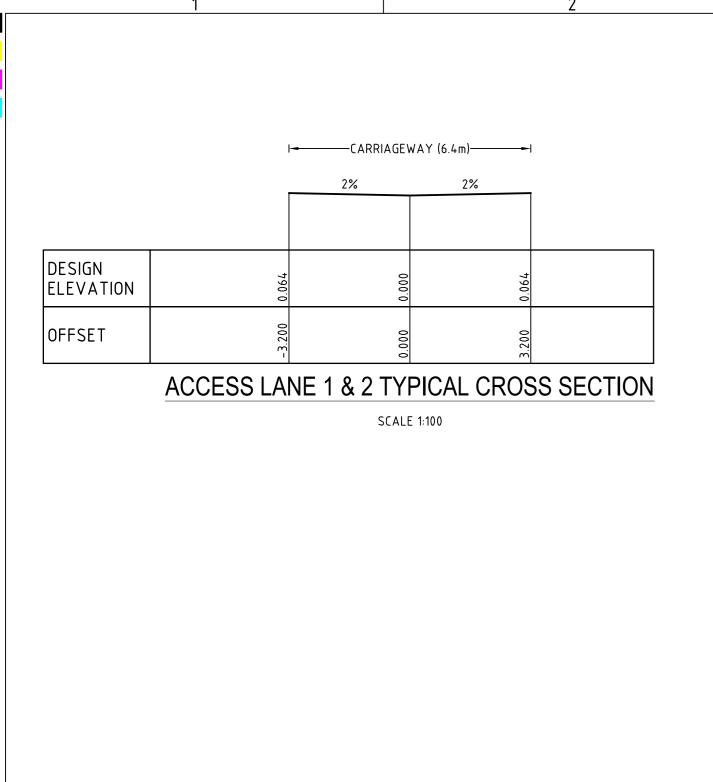

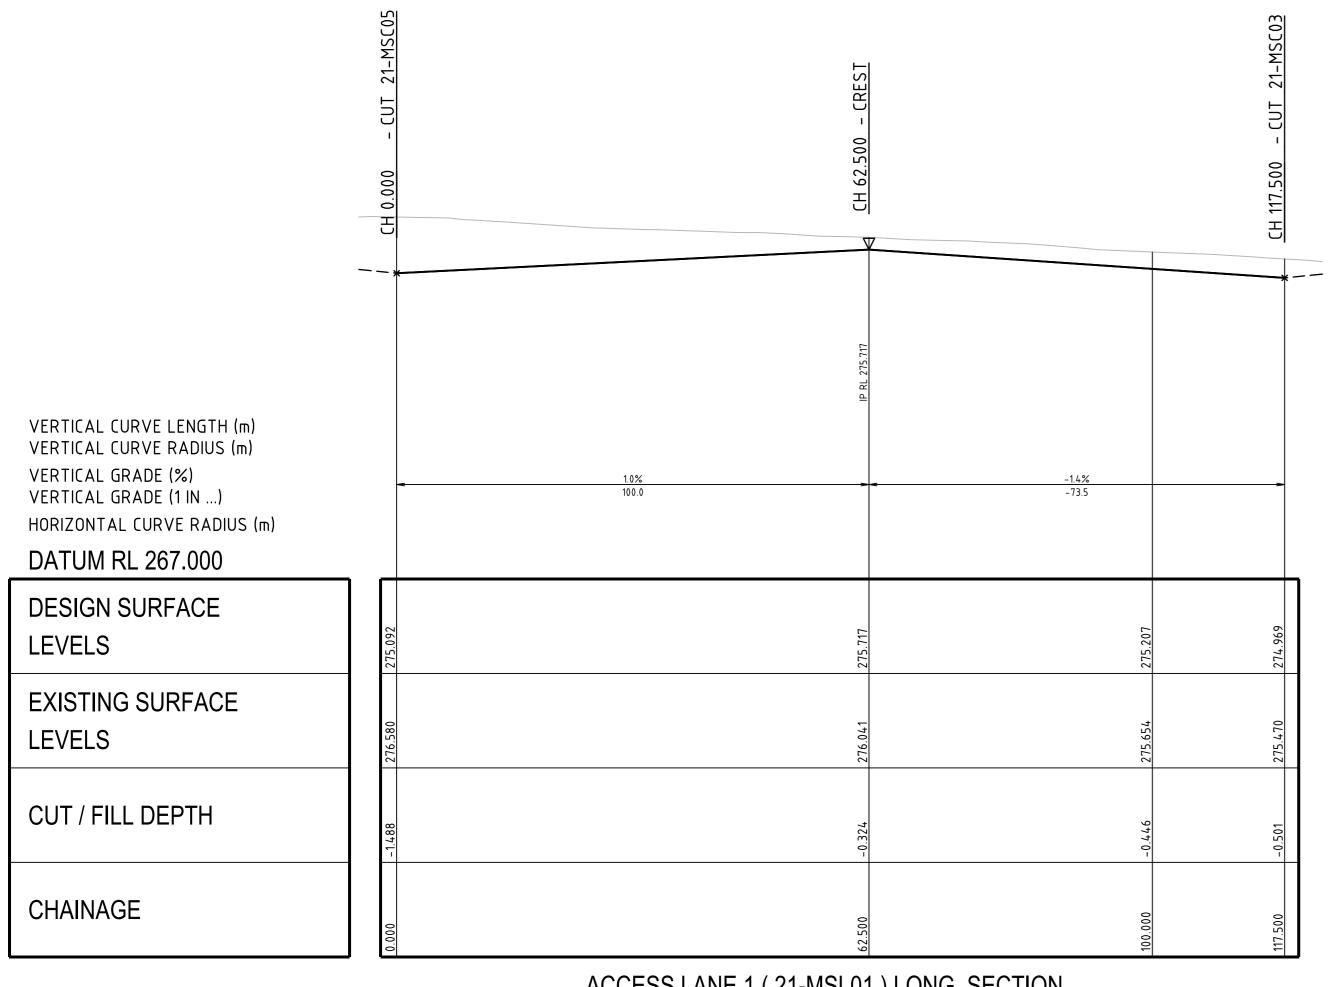

ACCESS LANE 1 (21-MSL01) LONG. SECTION

SCALE: HORIZONTAL - 1:500 VERTICAL - 1:100

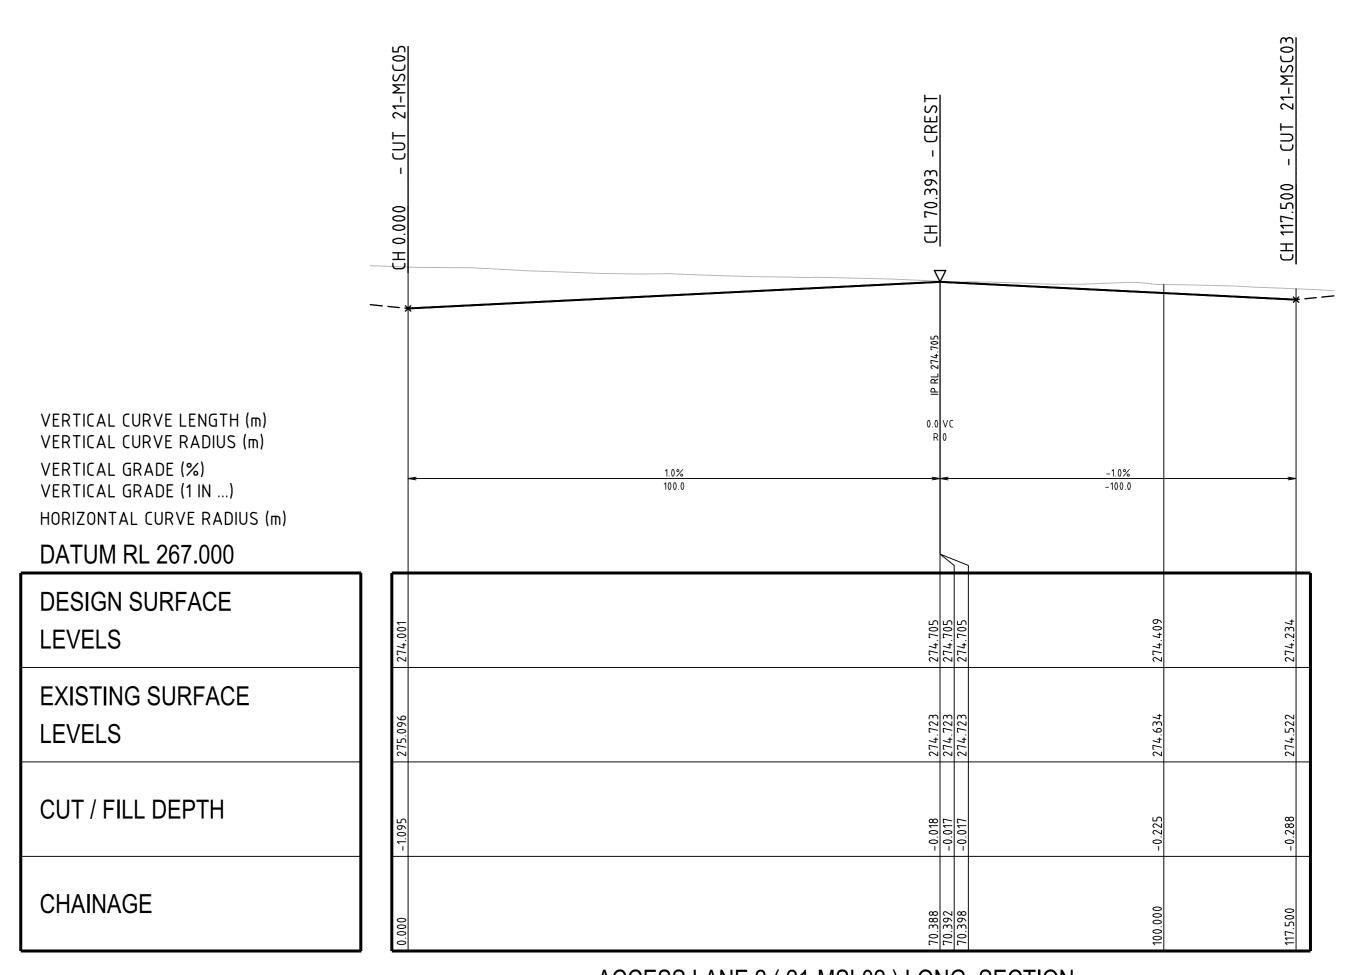

ACCESS LANE 2 (21-MSL02) LONG. SECTION

SCALE: HORIZONTAL - 1:500 VERTICAL - 1:100

DEVELOPMENT APPLICATION - NOT FOR CONSTRUCTION -

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≝ REV	/ DESCRIPTION	DATE	DRAWN DES	SIGNED	CHECKED A	APPRVD	SCALE	GRID	DATUM	PROJECT MANAGER	CLIENT
B	AMENDED AS PER UPDATED DESIGN	11/12/2019	RK CG	G/AVG	JF	JF	0 5 10 15 20 25 30 35 40 45 50	MCV	mAHD	15	COMMON GROUND PROPERTY P/L
A	INITIAL RELEASE	20/11/2019	GM CG	G/AVG	SA	JF	A1 (A3) 1:500 (1:1,000) METRES	MGA	IIIAND	JF	COMMON GROUND I NOI LIVITIZE
X X							0 1 2 3 4 5 6 7 8 9 10	DISCLAIMER	& COPYRIGHT		PROJECT NAME/PLANSET TITLE
USE							A1 (A3) 1:100 (1:200) METRES	This plan must not principal certifying		on unless signed as approved by	STRATFORD HOUSE LIFESTYLE VILLAGE
1								1	in millimetres unless o	therwise specified	
1 1										whole or part without prior written	PRELIMINARY ROADS DRAINAGE DESIGN
Ë									s & Associates Pty Ltd		STRATFORD HOUSE PRECINCT, TAHMOOR, NSW
7 N								(C) Copyright I	Martens & Associa	tes Pty Ltd	LOTS 1-7, 22, 23, 27-32, 35-37 DP 12096 & LOTS 2-3 DP236262
A1 / A3	3 LANDSCAPE (A1LC v02.0.01)	•			'		•	•			


	Consult
martens & Associates Pty Ltd	Enviror Water Geotec Civil


Suite 201, 20 George St, Hornsby, NSW 2077 Australia Phone: (02) 9476 9999 Fax: (02) 9476 8767 Email: mail@martens.com.au Internet: www.martens.com.au

Ilting Engineers chnical

ACCESS LANE 1 (21-MSL01) & 2 (21-MSL02) LONG. SECTIONS AND TYPICAL CROSS SECTION PLANSET NO. RELEASE NO. DRAWING NO. REVISION PS04-D213

DRAWING ID: P1907155-PS04-R03-D213

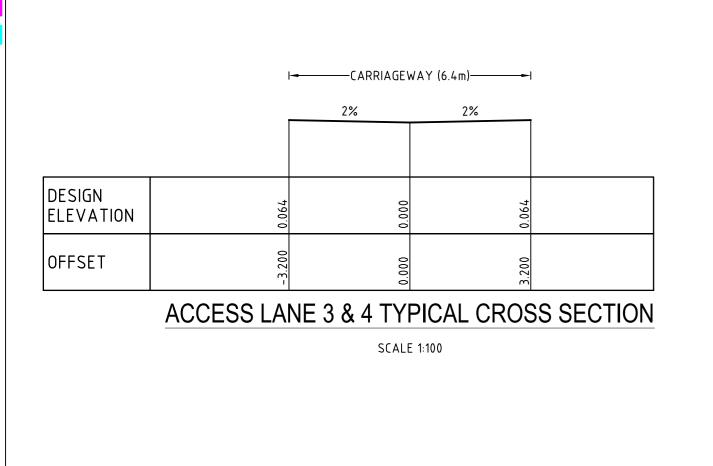

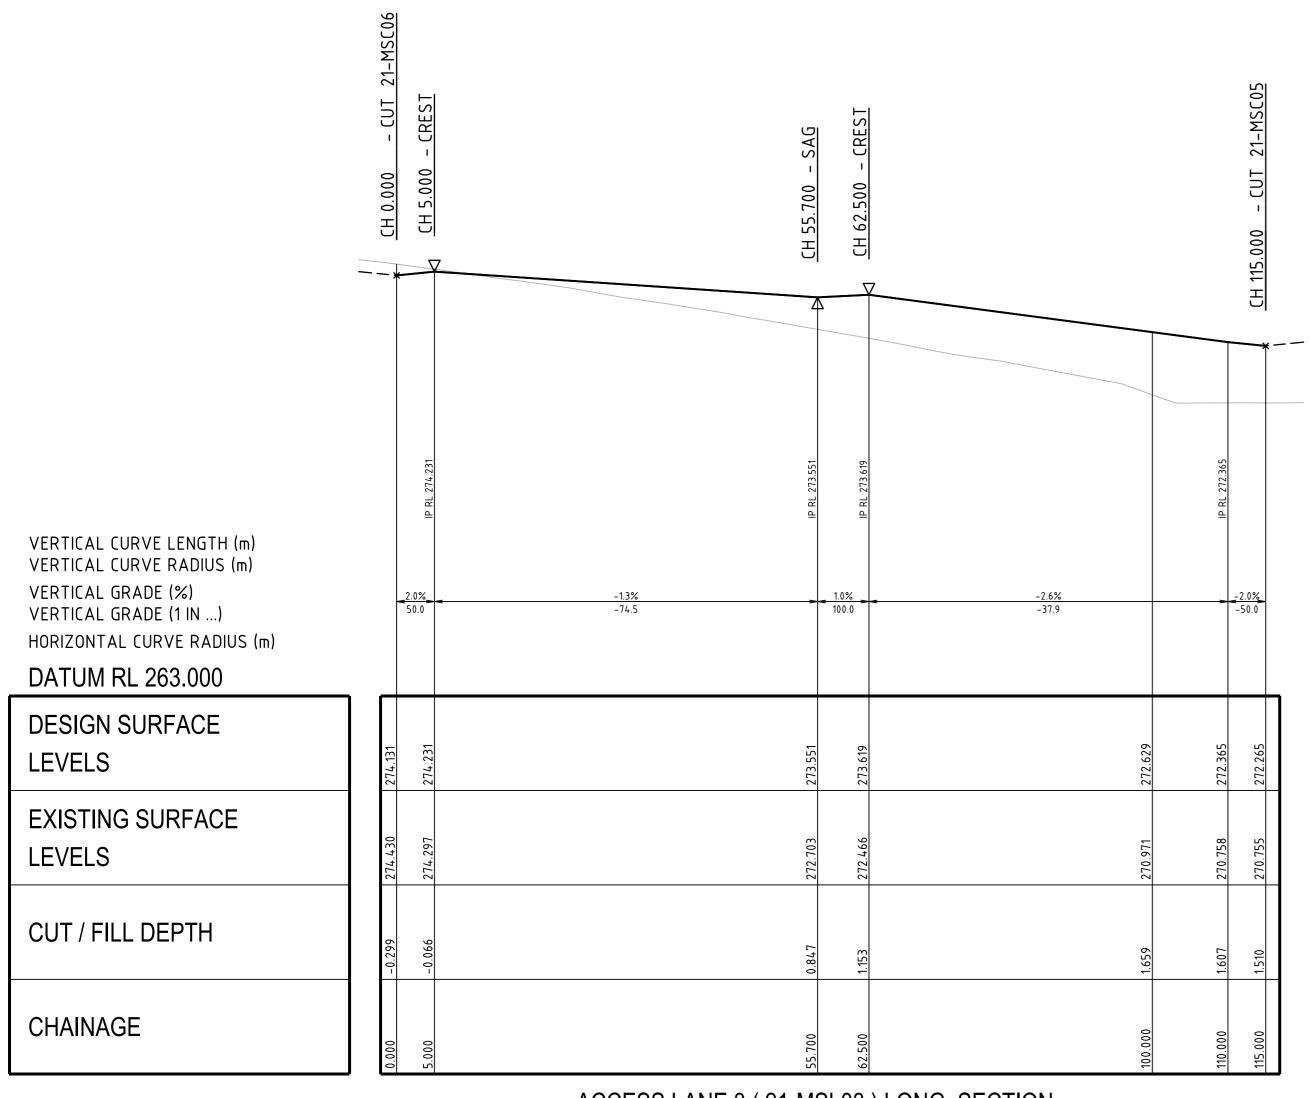

ACCESS LANE 3 (21-MSL03) LONG. SECTION

SCALE: HORIZONTAL - 1:500

VERTICAL - 1:100

ACCESS LANE 4 (21-MSL04) LONG. SECTION SCALE: HORIZONTAL - 1:500 VERTICAL - 1:100

VERTICAL CURVE LENGTH (m) VERTICAL CURVE RADIUS (m)

HORIZONTAL CURVE RADIUS (m)

VERTICAL GRADE (%)

VERTICAL GRADE (1 IN ...)

DATUM RL 265.000

DESIGN SURFACE

EXISTING SURFACE

CUT / FILL DEPTH

LEVELS

LEVELS

CHAINAGE


DEVELOPMENT APPLICATION - NOT FOR CONSTRUCTION -

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₹ REV	DESCRIPTION	DATE	DRAWN	DESIGNED	CHECKED	APPRVD	SCALE					GRID	DATUM	PROJECT MANAGER	CLIENT	
00Д В	AMENDED AS PER UPDATED DESIGN	11/12/2019	RK	CG/AVG	JF	JF	0 5 10 15 20	25 30	35	40	45 50	MGA	mAHD	l IE	COMMON GROUND PROPERTY P/L	
A OLA	INITIAL RELEASE	20/11/2019	GM	CG/AVG	SA	JF	A1 (A3) 1:500 (1:1,000)				METRES	MUA	IIIANU) JF	COMMON GROUND I NOI LIVI I 1/L	
XX.							0 1 2 3 4	5 6	7	8	9 10	DISCLAIMER 8	COPYRIGHT		PROJECT NAME/PLANSET TITLE]
USEF							A1 (A3) 1:100 (1:200)				METRES	This plan must not principal certifying		on unless signed as approved by	STRATFORD HOUSE LIFESTYLE VILLAGE	
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₽												1	,		STRATFORD HOUSE PRECINCT, TAHMOOR, NSW	Su
<u> </u>												(C) Copyright N	lartens & Associa	ites Pty Ltd	LOTS 1-7, 22, 23, 27-32, 35-37 DP 12096 & LOTS 2-3 DP236262	
A1 / A3 L	LANDSCAPE (A1LC_v02.0.01)		1	1			1									

Consulting Engineers martens & Associates Pty Ltd


ACCESS LANE 3 (21-MSL03) & 4 (21-MSL04) LONG. SECTIONS AND TYPICAL CROSS SECTION

PLANSET NO. RELEASE NO. DRAWING NO. PROJECT NO. REVISION Suite 201, 20 George St, Hornsby, NSW 2077 Australia Phone: (02) 9476 9999 Fax: (02) 9476 8767 Email: mail@martens.com.au Internet: www.martens.com.au PS04-D214 DRAWING ID: P1907155-PS04-R03-D214 0 0 10 20 30 40 50 60 70 80 90 100

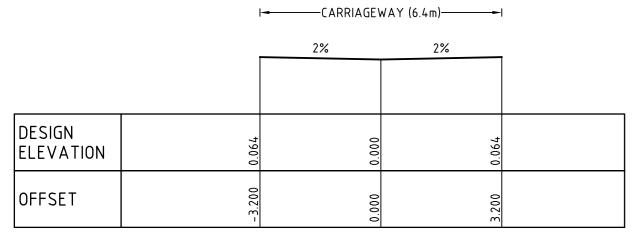

ACCESS LANE 7 TYPICAL CROSS SECTION

SCALE 1:100

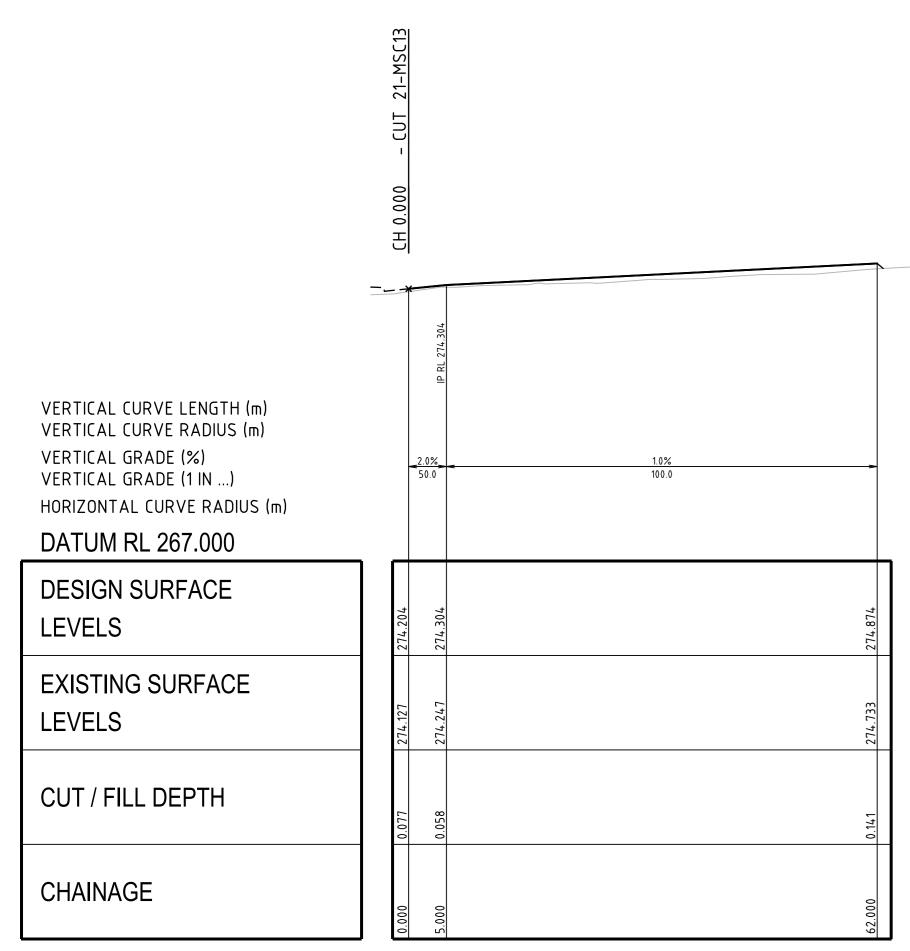

A1 / A3 LANDSCAPE (A1LC_v02.0.01)

ACCESS LANE 7 (21-MSL07) LONG. SECTION

SCALE: HORIZONTAL - 1:500 VERTICAL - 1:100

DEVELOPMENT APPLICATION - NOT FOR CONSTRUCTION -

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HZ R	EV DESCRIPTION	DATE	DRAWN	DESIGNED	CHECKED APPRVD	'D SCAL	LE							GRID	DATUM	PROJECT MANAGER	CLIENT	
1000	B AMENDED AS PER UPDATED DESIGN	11/12/2019	RK	CG/AVG	JF JF	0	5 10	15 20	25	30	35 40	45	50	MGA	mAHD	IE	COMMON GROUND PROPERTY P/L	
OLAH	A INITIAL RELEASE	20/11/2019	GM	CG/AVG	SA JF	A1 ((A3) 1:500 (1	I:1,000)					METRES	MUA	IIIANU	JF	COMMON GROOND I ROI LIVI I /L	
:: X						0	12	3 4	5	6	7 8	9	10	DISCLAIMER	& COPYRIGHT		PROJECT NAME/PLANSET TITLE	
USEF						A1 ((A3) 1:100 (1:	:200)					METRES	This plan must not principal certifying		on unless signed as approved by	STRATFORD HOUSE LIFESTYLE VILLAGE	1
1															•	thornian annaified	STIATIOND HOUSE LIFESTILE VILLAGE	
															in millimetres unless of t not be reproduced in v	whole or part without prior written	PRELIMINARY ROADS DRAINAGE DESIGN	
IED														consent of Marten	s & Associates Pty Ltd.		STRATFORD HOUSE PRECINCT, TAHMOOR, NSW	Sı
PRIN														(C) Copyright I	Martens & Associa	tes Pty Ltd	LOTS 1-7, 22, 23, 27-32, 35-37 DP 12096 & LOTS 2-3 DP236262	


martens & Associates Pty Ltd


Consulting Engineers
Environment
Water
Geotechnical
Civil


& Associates Pty Ltd Geotechnical Civil


Suite 201, 20 George St, Hornsby, NSW 2077 Australia Phone: (02) 9476 9999 Fax: (02) 9476 8767 Email: mail@martens.com.au Internet: www.martens.com.au


ACCE	•	21-MSL07) CAL CROSS S	LONG. SECTION SECTION	
PROJECT NO.	PLANSET NO.	RELEASE NO.	DRAWING NO.	REVISION

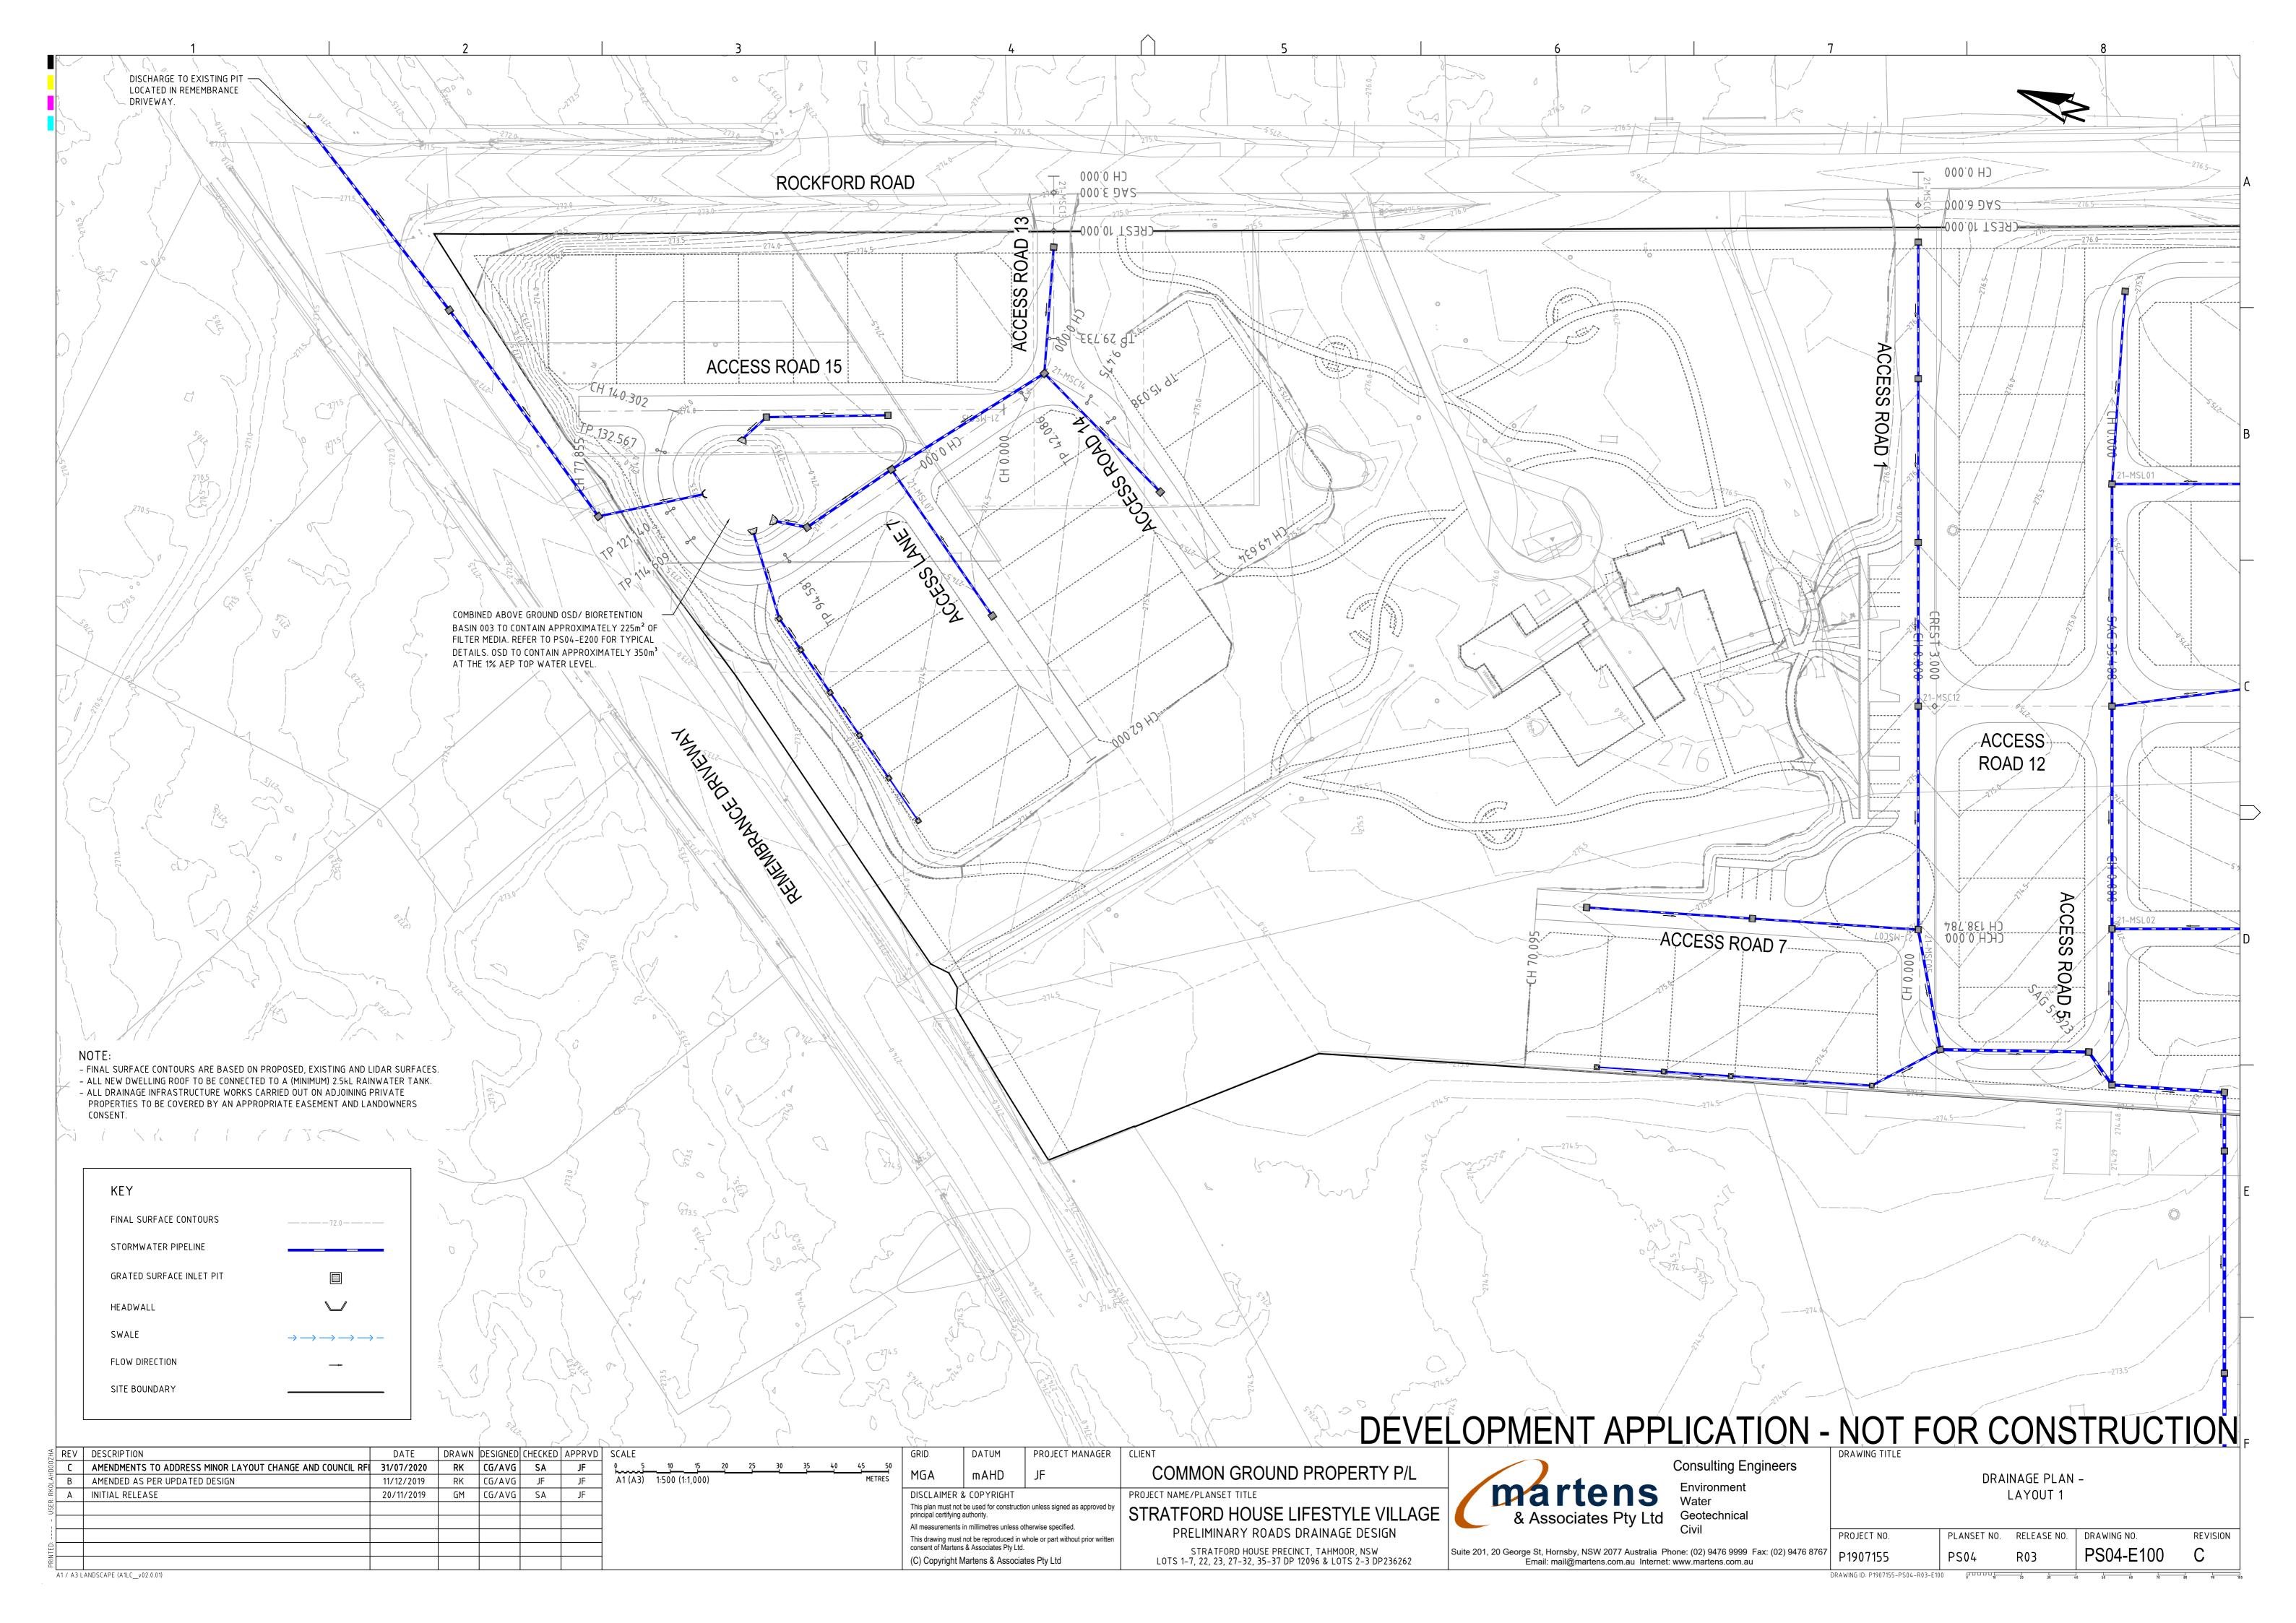


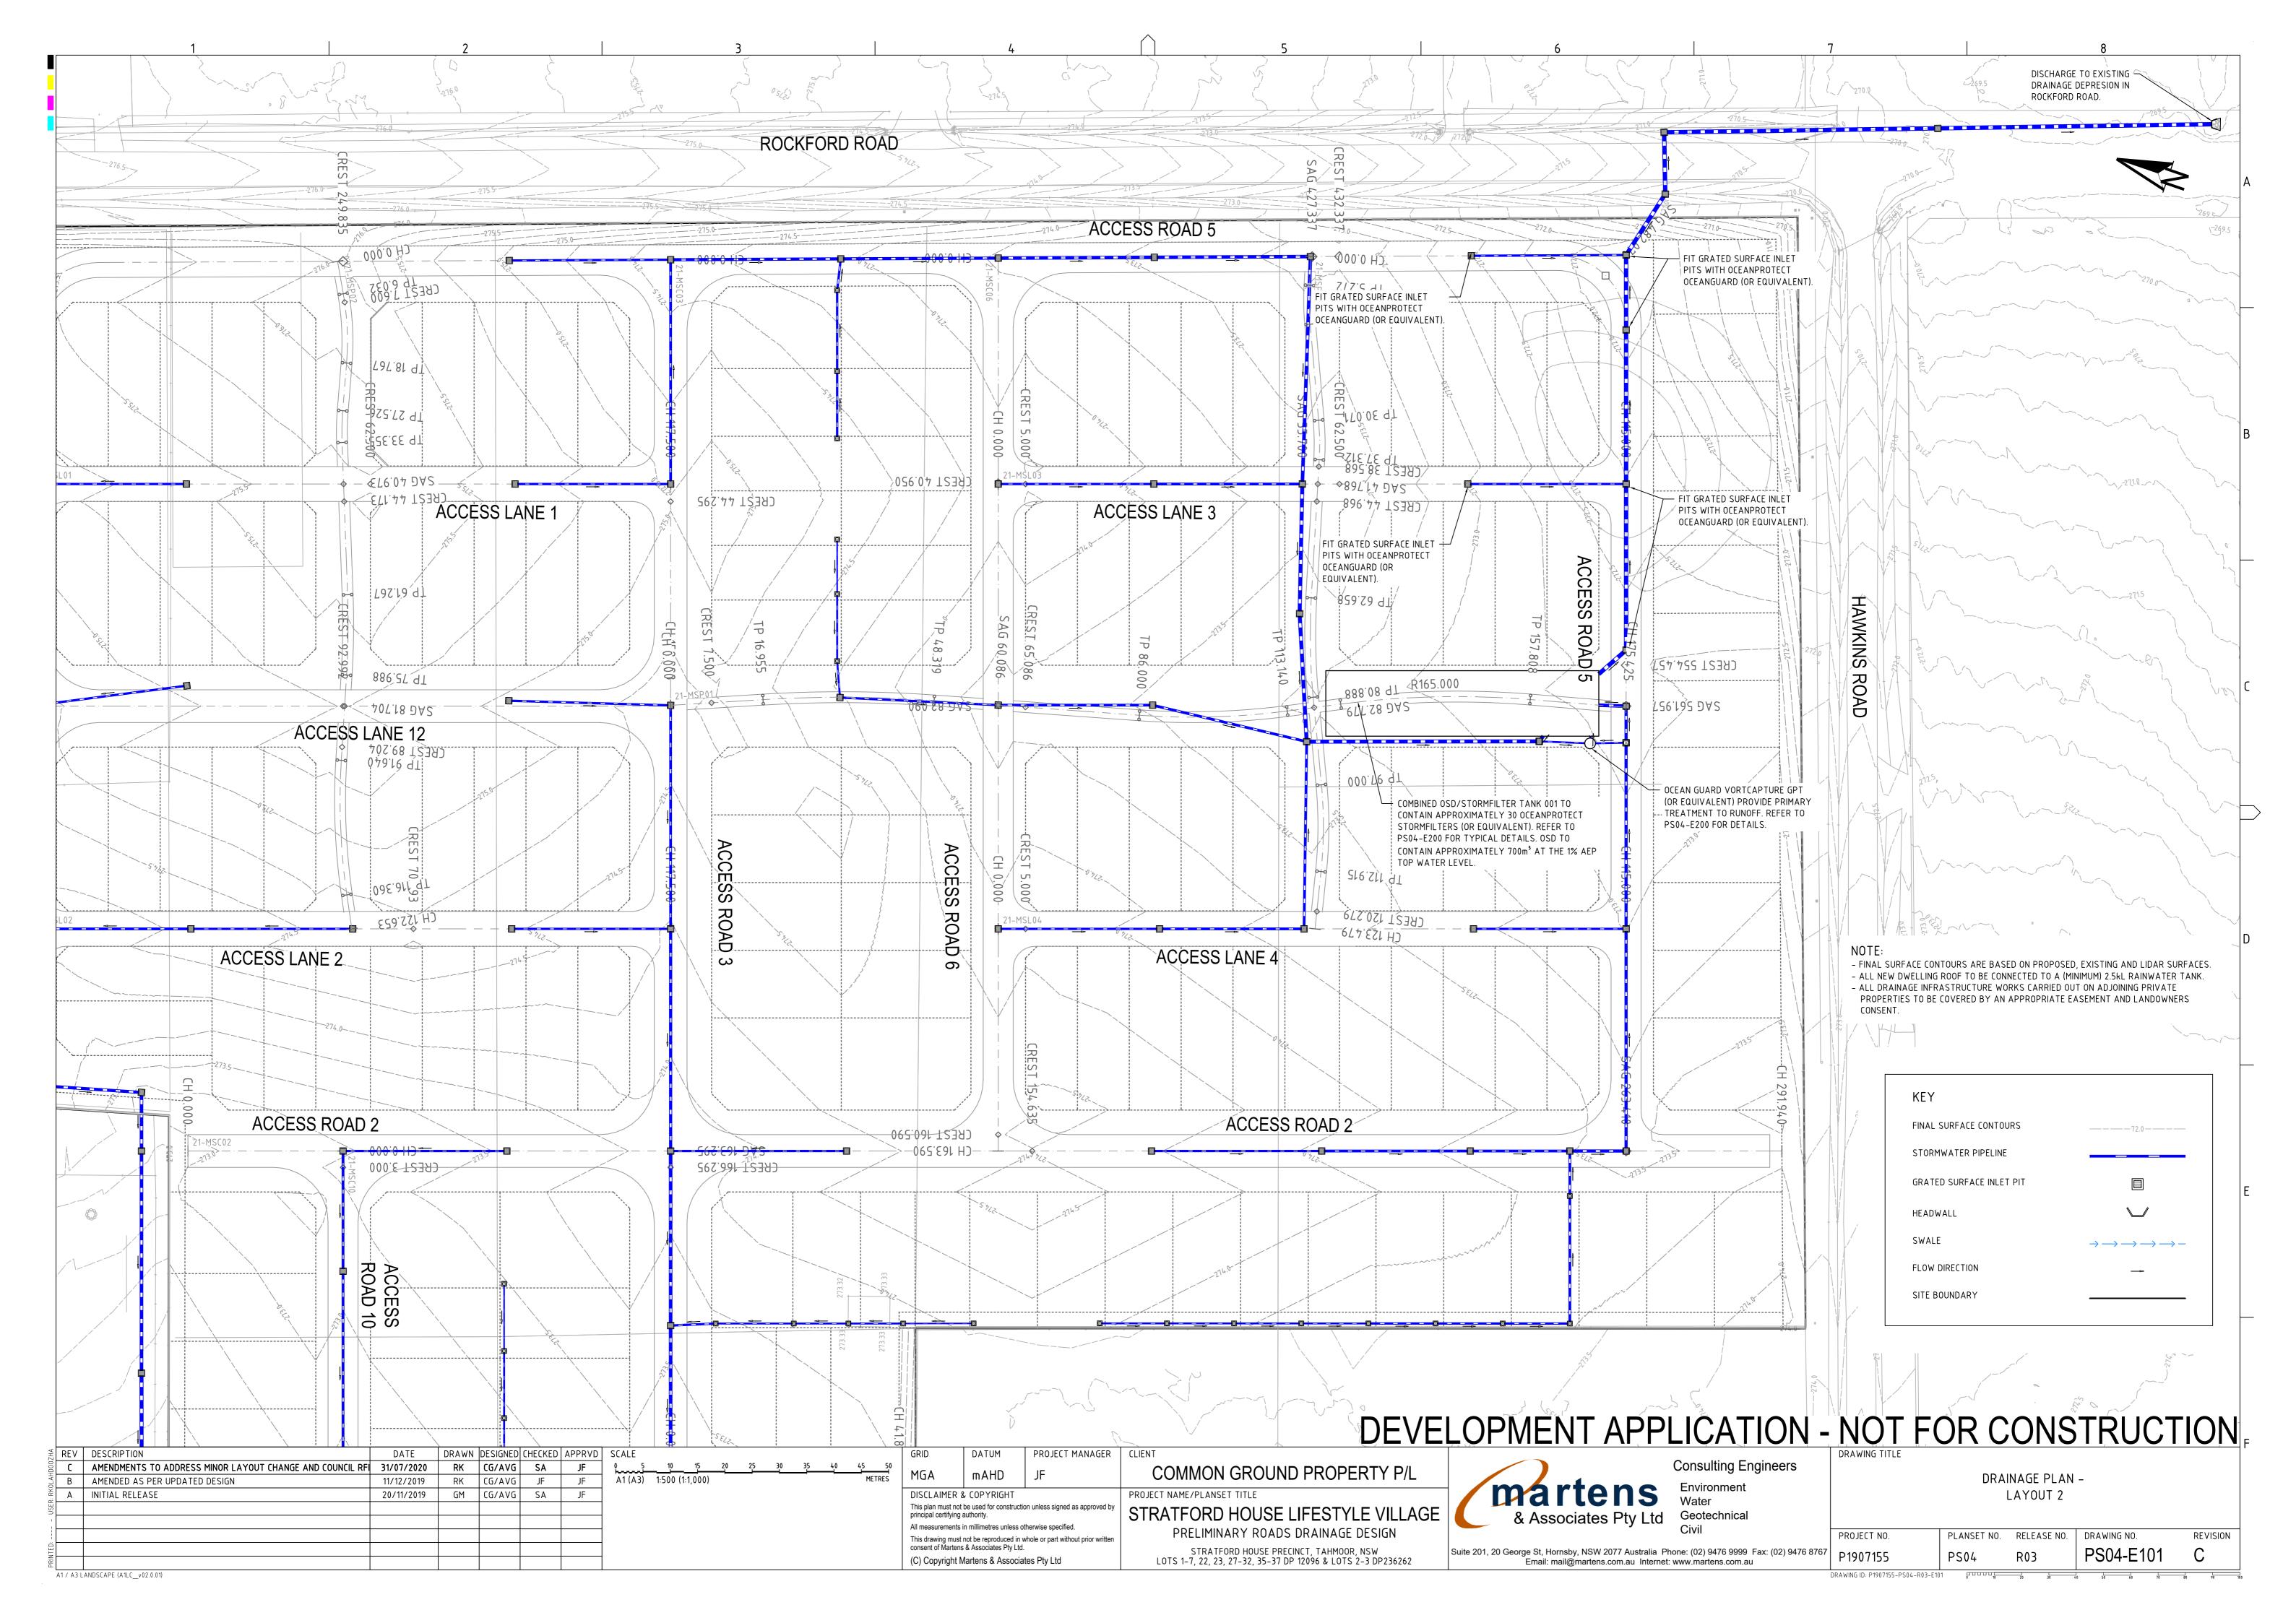


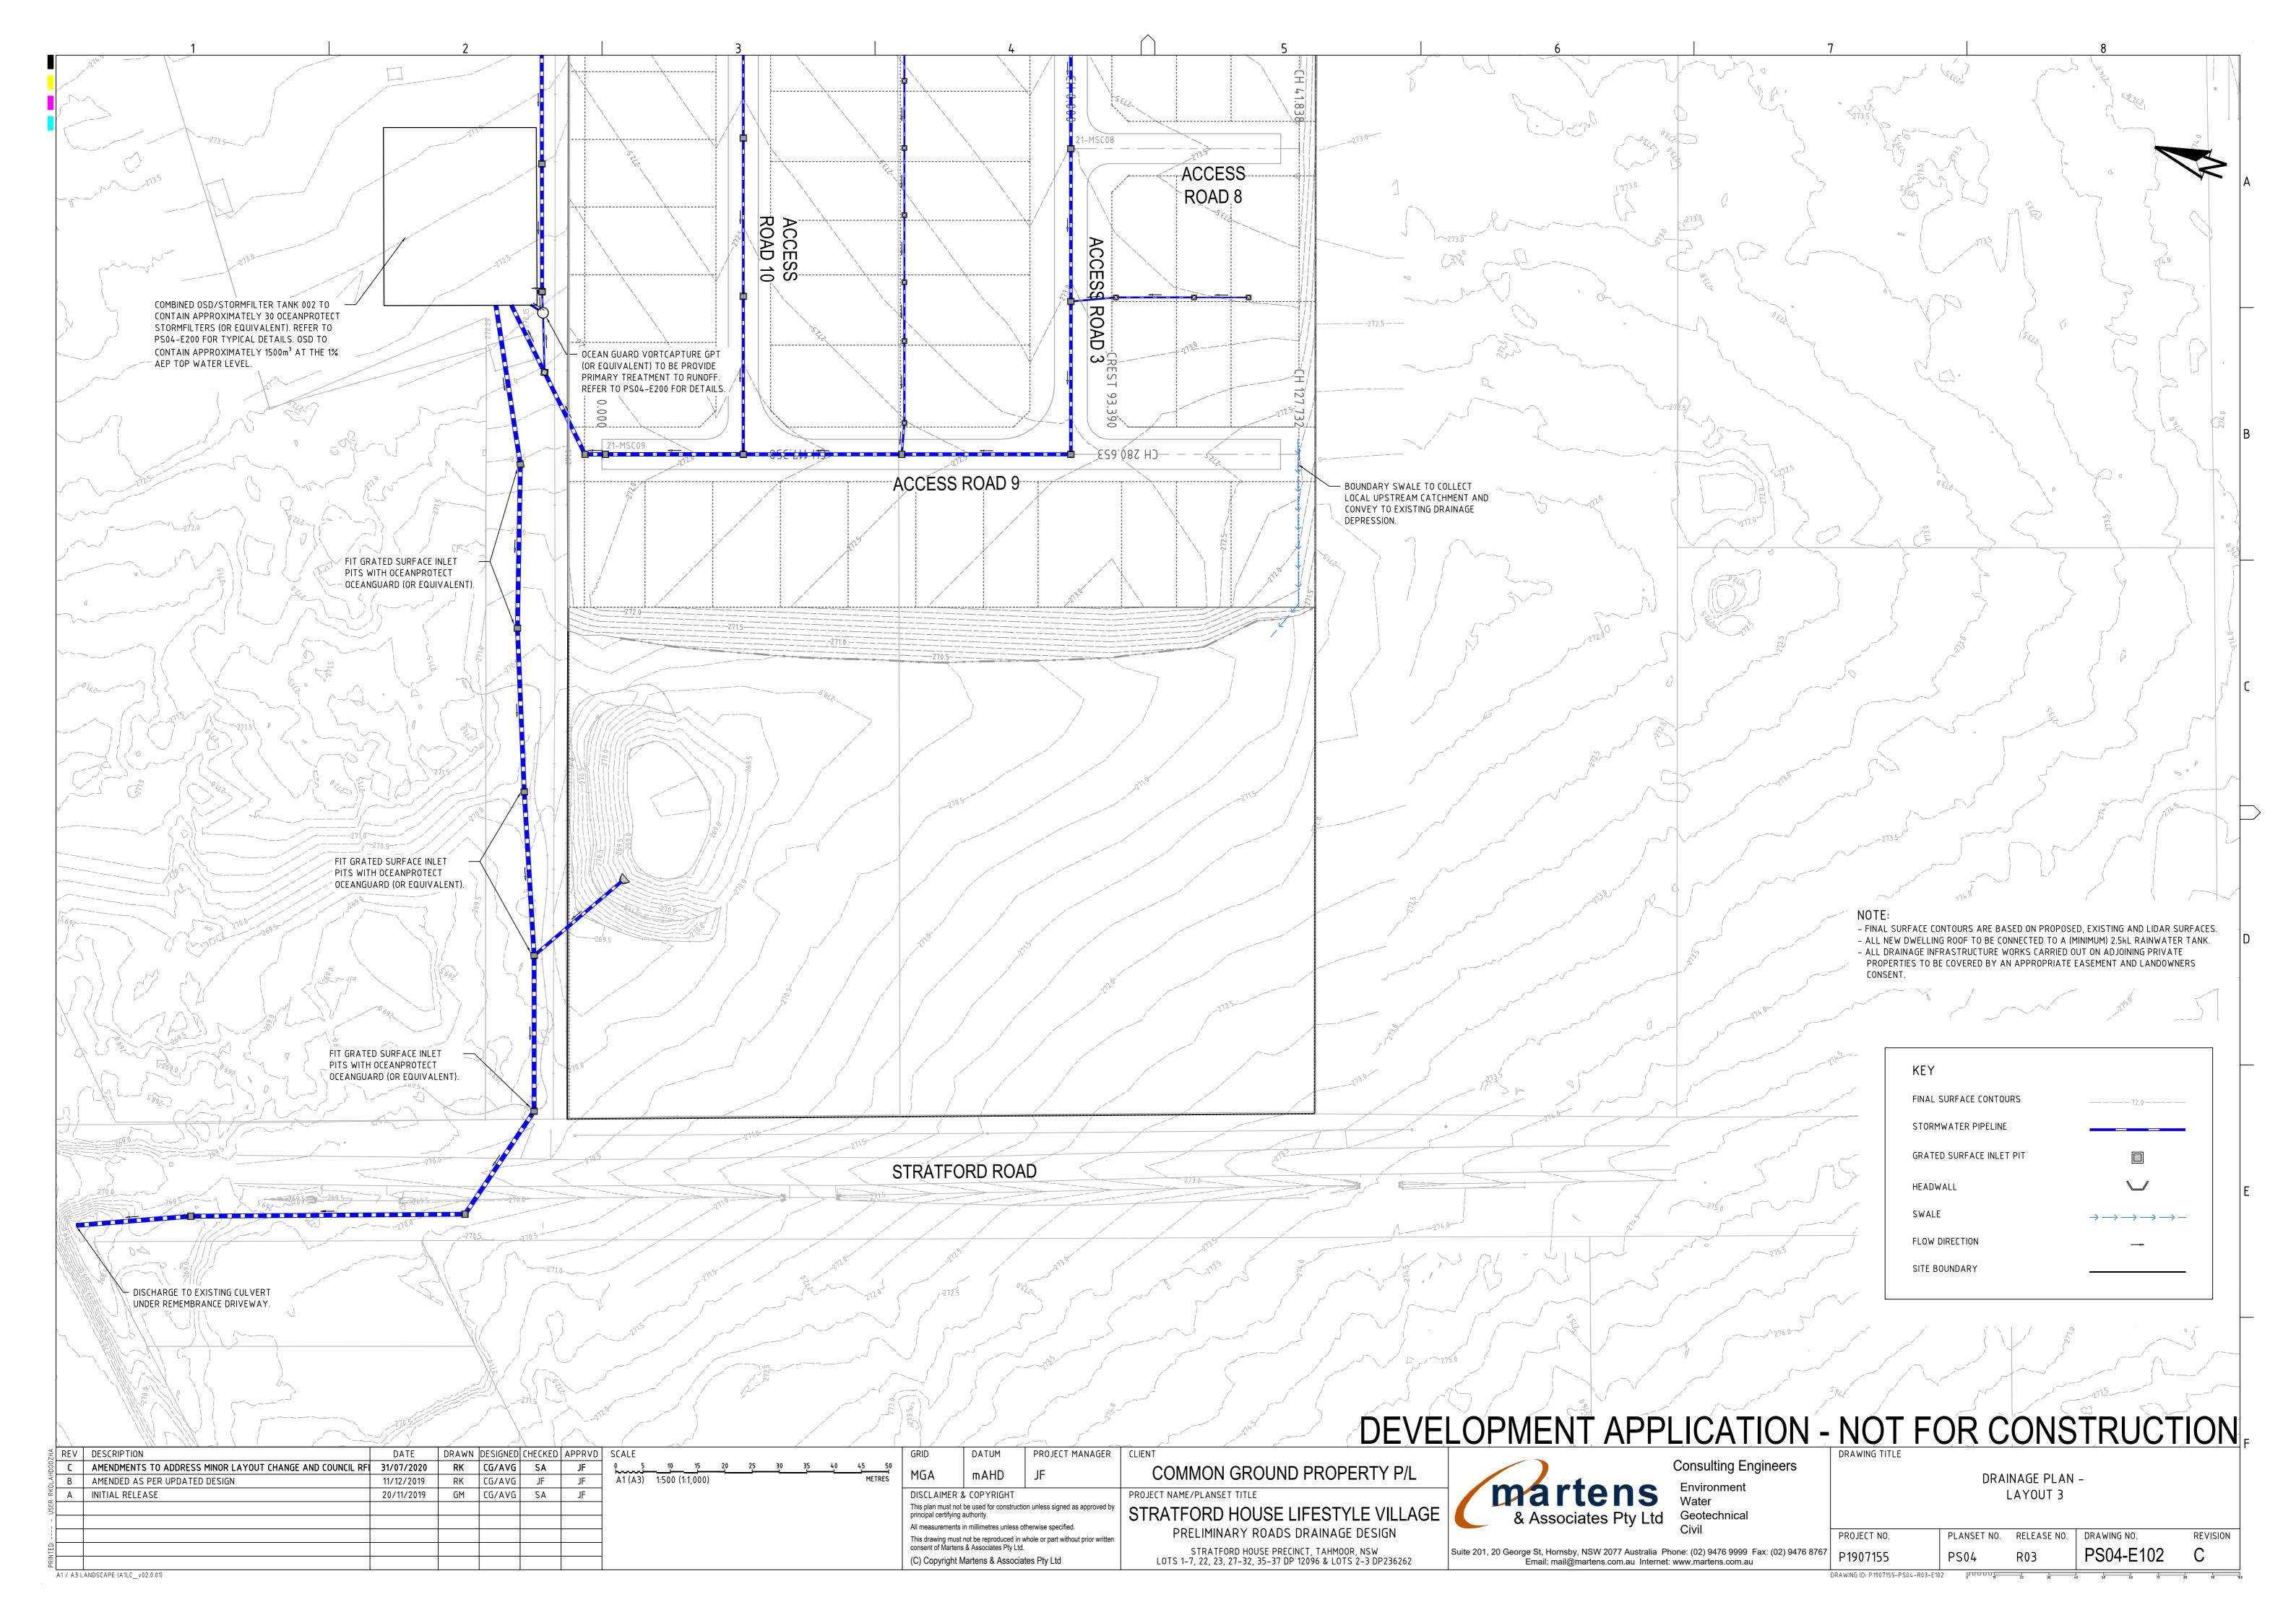

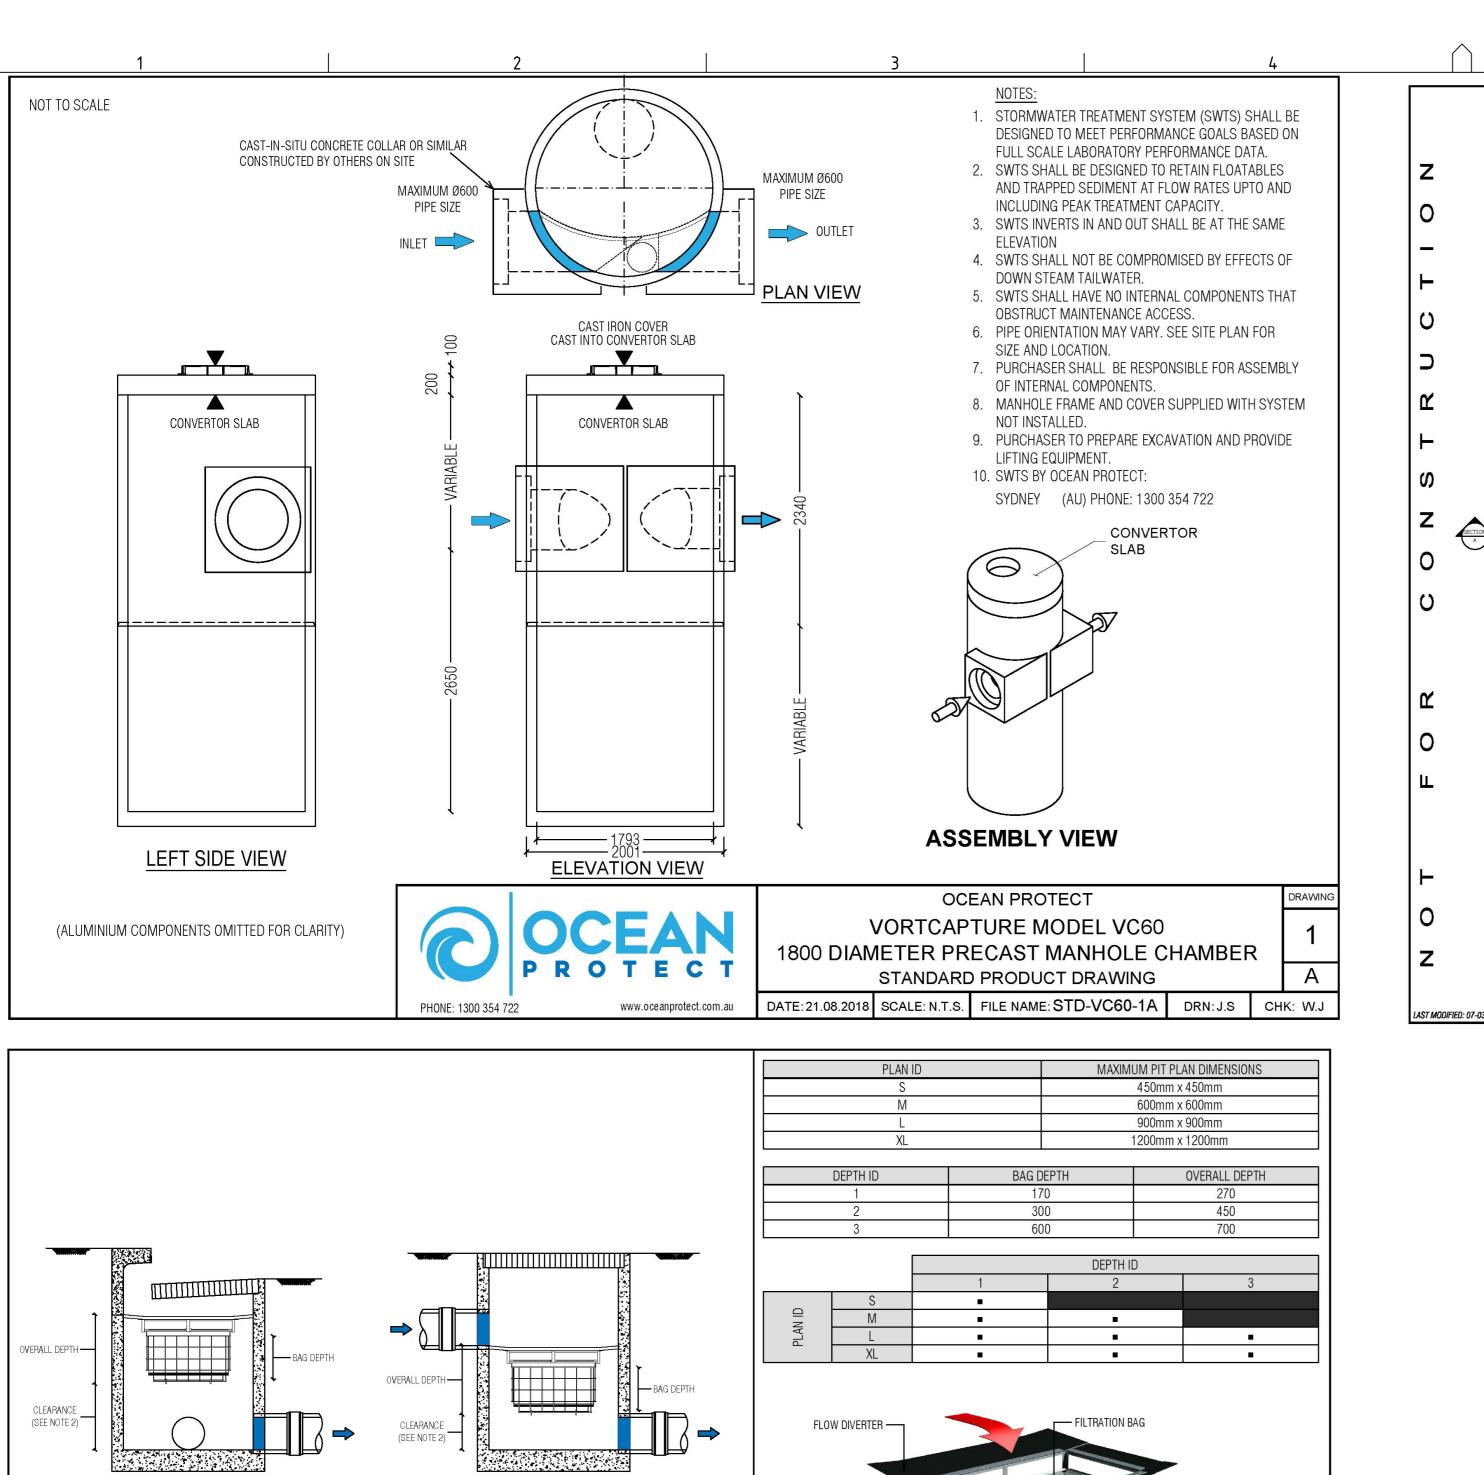


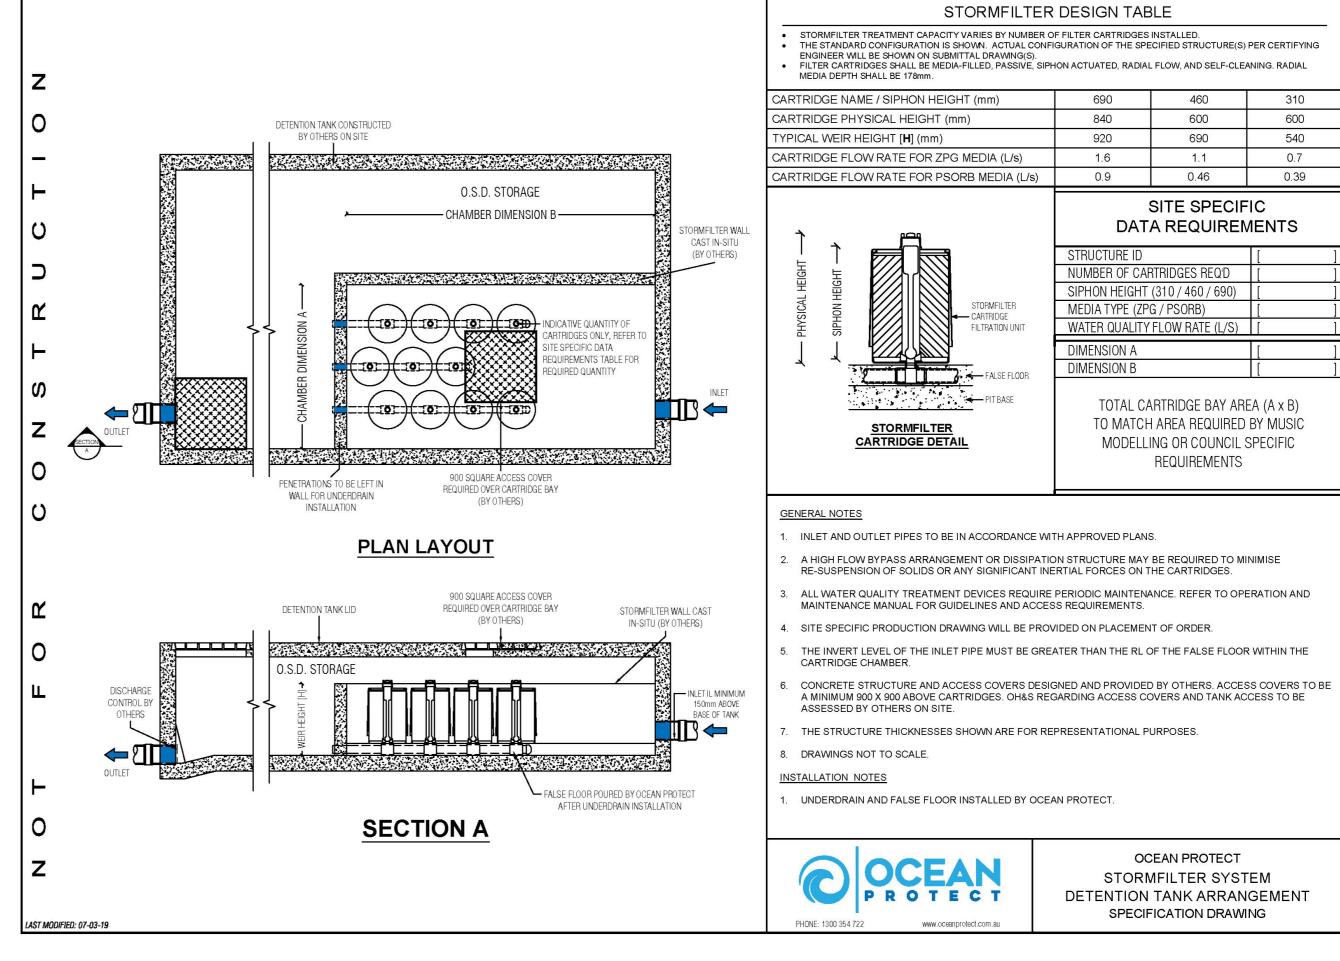

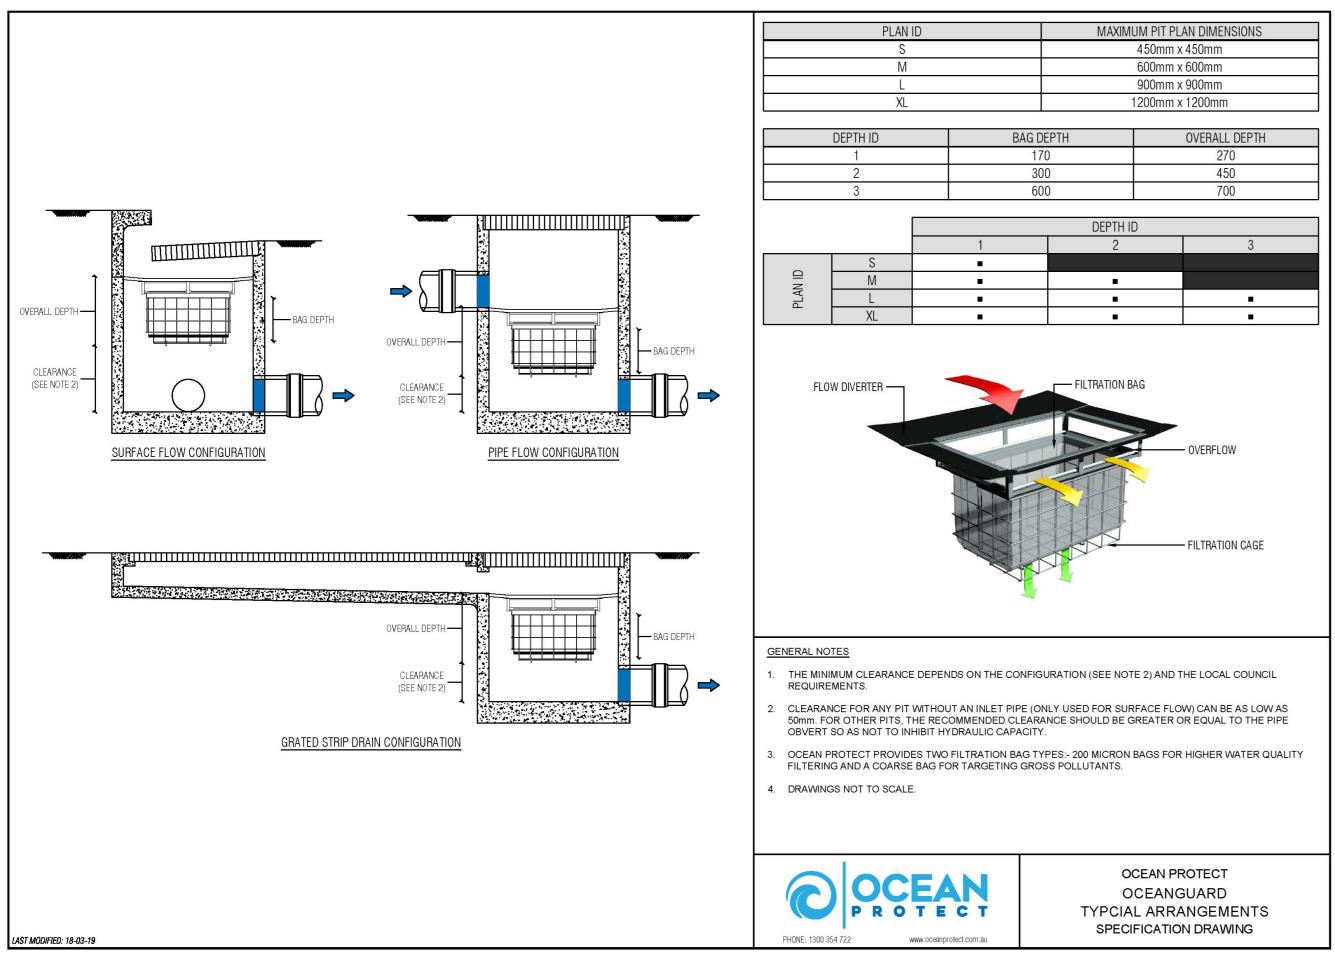

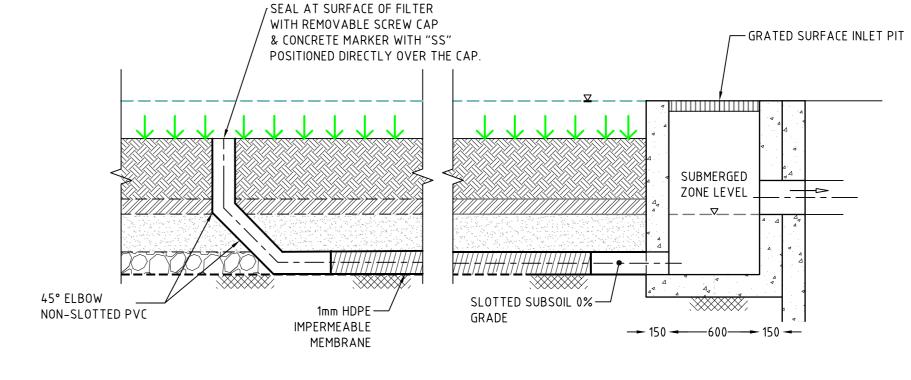


TYPICAL BIORETENTION SECTION

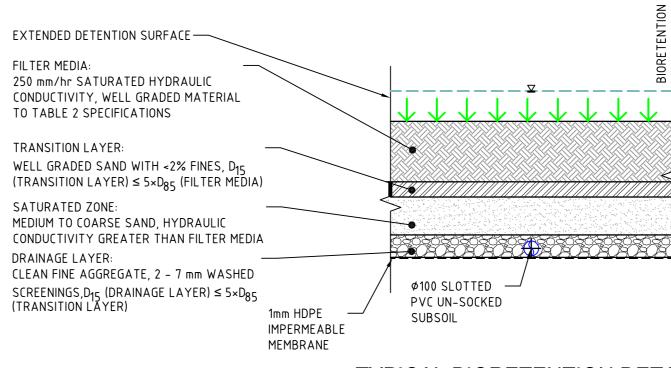


TYPICAL BIORETENTION DETAIL

DEVELOPMENT APPLICATION - NOT FOR CONSTRUCTION

	LAST MODIFIED. 10-03-13		THORE, 1000 004 722 IIIII.00casproteot.com.ad		\dashv \sqcup			しいい しんけい		\mathbf{I}
REV	DESCRIPTION	DATE DRAWN DESIGNED CHECKED APPRVD SCALE	<u> </u>	GRID DATUM PR	OJECT MANAGER CLIENT		DRAWING TITLE			11011
B A	AMENDED AS PER UPDATED DESIGN INITIAL RELEASE	11/12/2019 RK CG/AVG JF JF 1/2019 GM CG/AVG SA JF A1 (A	5 10 15 20 25 30 35 40 45 50 A3) 1:500 (1:1,000) METRES	JF	COMMON GROUND PROPERTY P/L	Consulting Engineers		TYPICAL DRAINA	GE DETAILS	
R RKO			·	DISCLAIMER & COPYRIGHT	PROJECT NAME/PLANSET TITLE	martens Environment Water				!
- USE				This plan must not be used for construction unle principal certifying authority.	STRATFORD HOUSE LIFESTYLE VILLAGE	E & Associates Pty Ltd Geotechnical				
				All measurements in millimetres unless otherwis This drawing must not be reproduced in whole of	PRELIMINARY ROADS DRAINAGE DESIGN	Civil	PROJECT NO.	PLANSET NO. RELEAS		REVISION
PRINTE				consent of Martens & Associates Pty Ltd. (C) Copyright Martens & Associates P	STRATFORD HOUSE PRECINCT, TAHMOOR, NSW ty Ltd LOTS 1-7, 22, 23, 27-32, 35-37 DP 12096 & LOTS 2-3 DP236262	Suite 201, 20 George St, Hornsby, NSW 2077 Australia Phone: (02) 9476 9999 Fax: (02) 9476 8767 Email: mail@martens.com.au Internet: www.martens.com.au	P1907155	PS04 R03	PS04-E200	В
A1 / A3	B LANDSCAPE (A1LC_v02.0.01)				,	,	DRAWING ID: P1907155-PS04-R03	3-E200 0 0 0 0 0 0 0 0 0 0 0 0 0 0 0 0 0 0	1 0 40 50 60 70	80 90

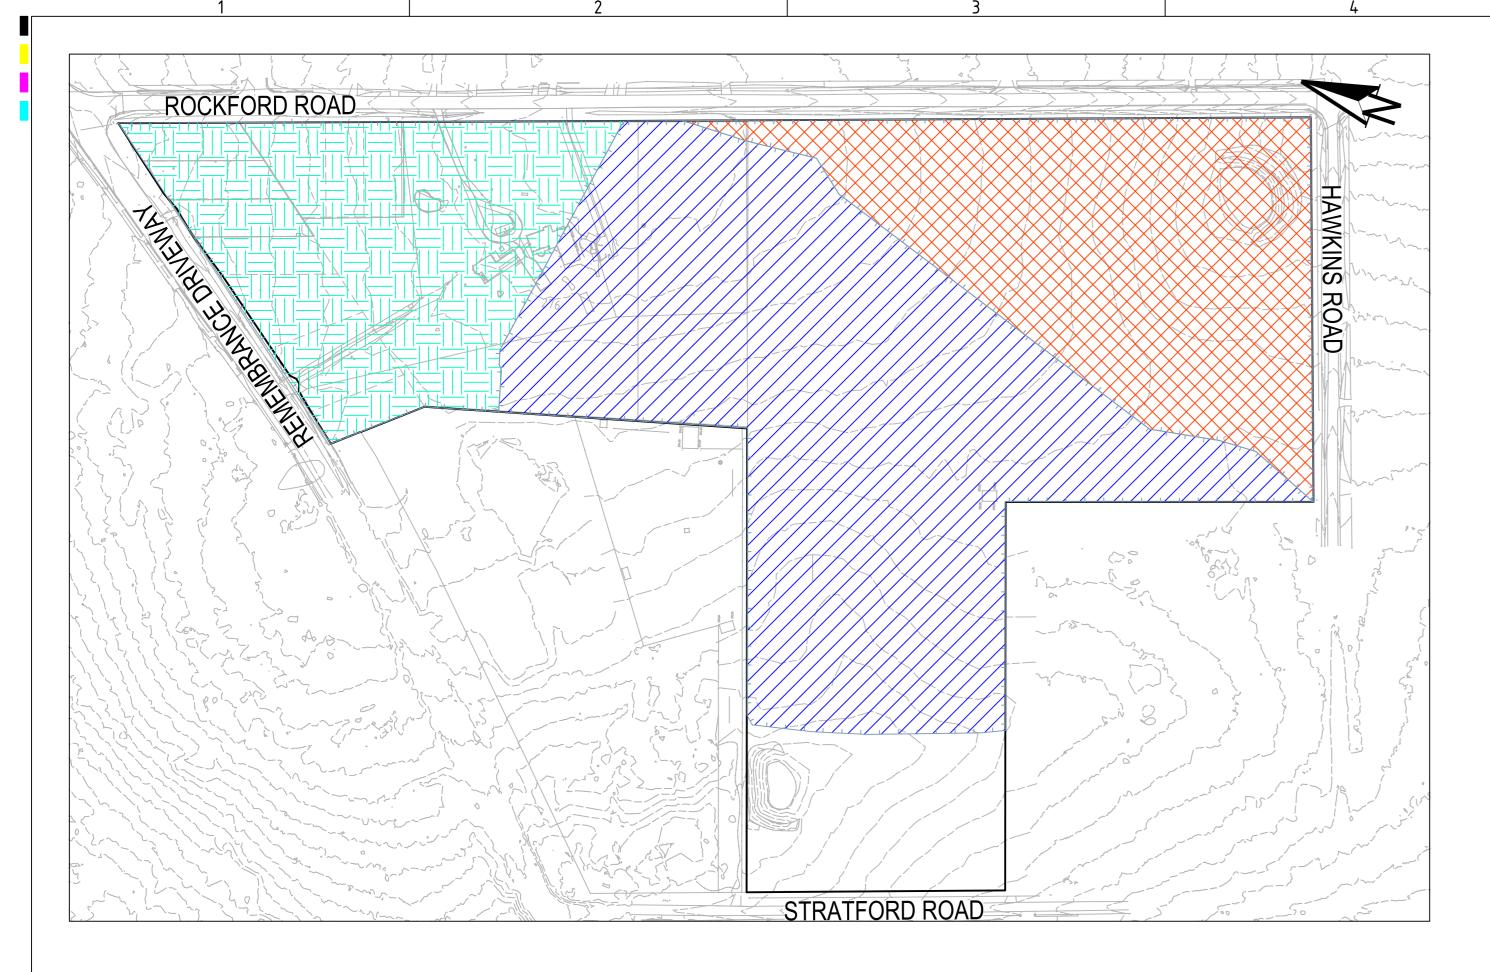

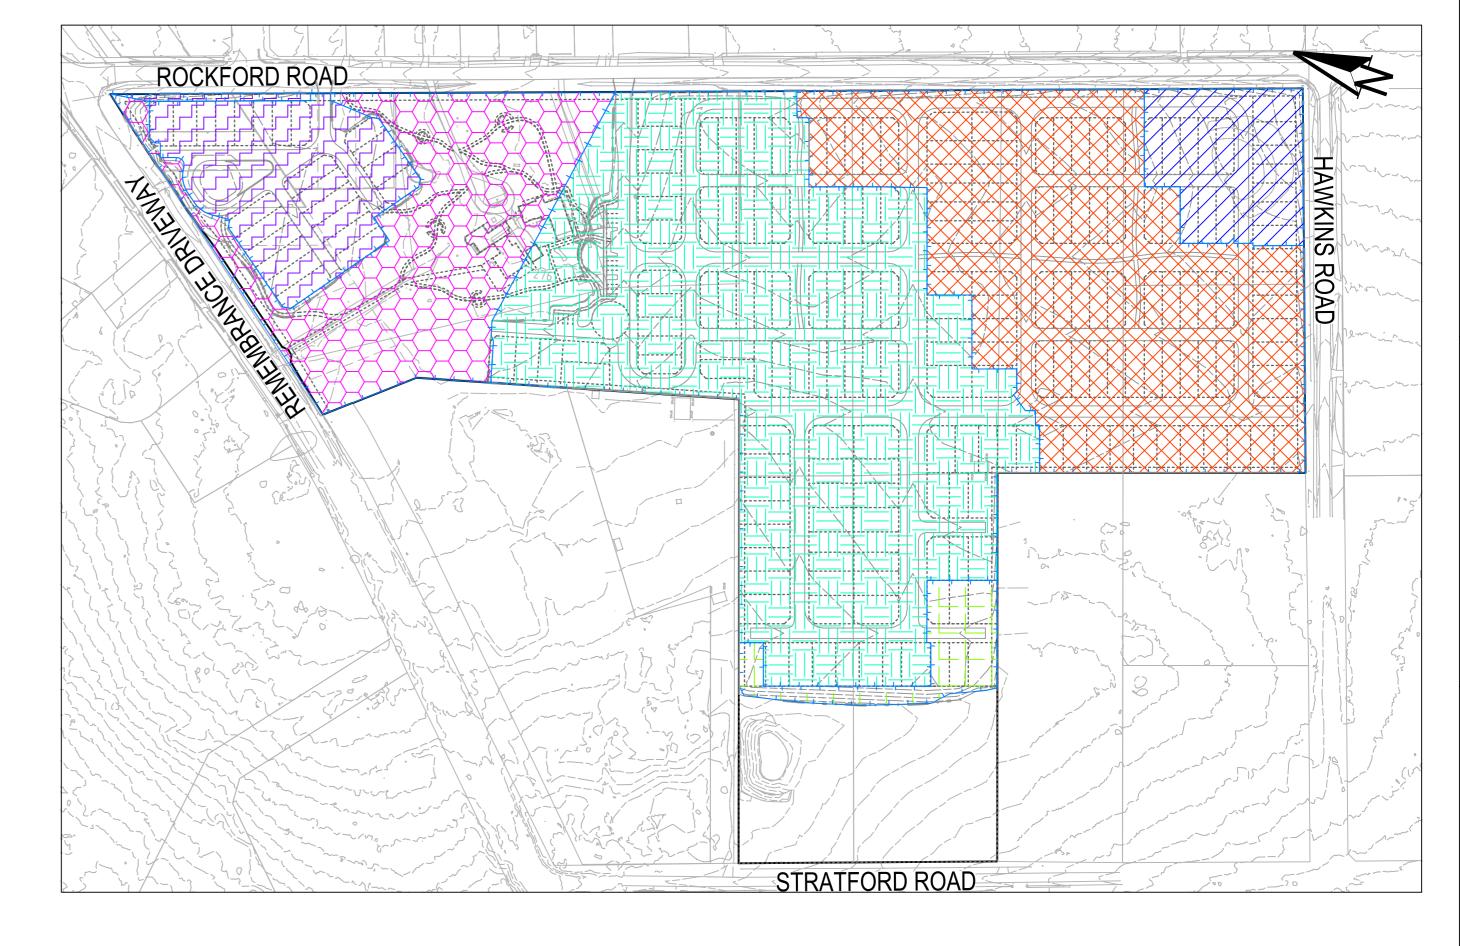


PRE-DEVELOPMENT OSD CATCHMENT PLAN

SCALE 1:2000

PRE-DEVELOPMENT OSD MODELLING DETAILS (P1907155DRN01V02) DRAINS NODE | AREA (ha) % PAVED 0% 2A-01 6.09 3% 5% 2.76 = 100% OF TOTAL AREA TOTAL AREA 12.16 TOTAL IMPERVIOUS AREA = %3 OF TOTAL AREA 0.31 = %97 OF TOTAL AREA TOTAL PERVIOUS AREA 11.85

A1 / A3 LANDSCAPE (A1LC_v02.0.01)

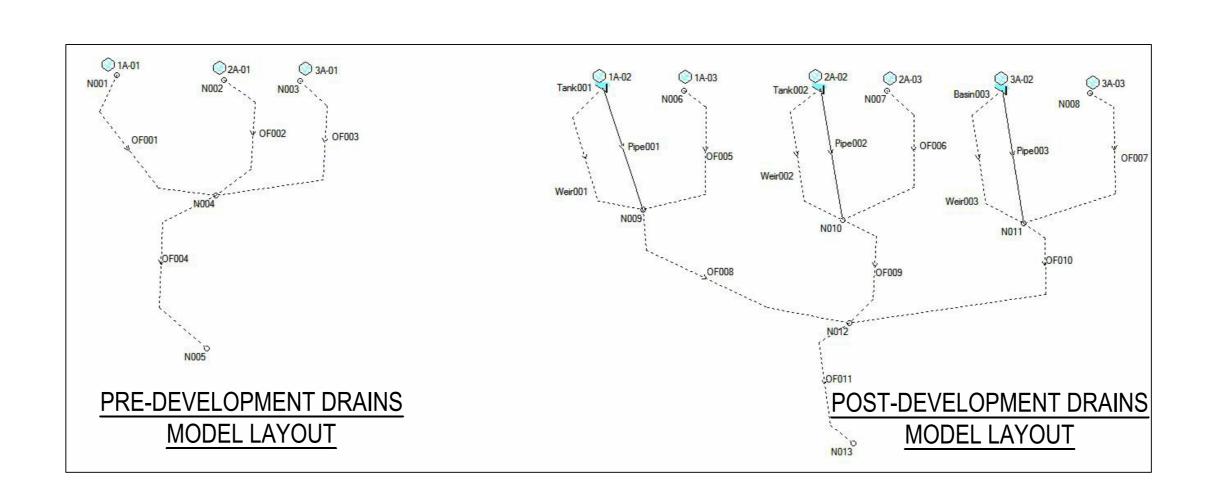

POST-DEVELOPMENT OSD CATCHMENT PLAN

SCALE 1:2000

	DEVELOPM ETAILS (P19		MODELLING N01V02)
KEY	DRAINS NODE	AREA (ha)	% PAVED
	1A-02	3.35	70%
	1A-03	0.63	70%
	2A-02	5.07	70%
	2A-03	0.34	70%
	3A-02	0.98	70%
	3A-03	1.78	7%
TOTAL AREA		12.16	= 100% OF TOTAL AREA
TOTAL IMPERVIO	DUS AREA	7.39	= %61 OF TOTAL AREA
TOTAL PERVIOU	S AREA	4.77	= %39 OF TOTAL AREA

	1 EY				0.5 EY				0.2 EY				10% AEF)			5% AEP			;	2% AEP				1% AEP			
Duration	Pre	Post	Difference	Complies?	Pre	Post	Difference	Complies?	Pre	Post	Difference	Complies?	Pre	Post	Difference	Complies?	Pre	Post	Difference	Complies?	Pre	Post	Difference	Complies?	Pre	Post	Difference	Complies
10 min	0.057	0.604	-0.547	Yes Î	0.309	0.749	-0.440	Yes Î	0.694	0.938	-0.244	Yes Î	1.011	1.089	-0.078	Yes ^	1.388	1.264	0.124	Yes	1.925	1.507	0.418	Yes	2.372	1.705	0.667	Yes
15 min	0.091	0.652	-0.561	Yes ^	0.408	0.806	-0.398	Yes Î	0.871	1.022	-0.151	Yes ^	1.277	1.192	0.085	Yes	1.731	1.391	0.340	Yes	2.378	1.658	0.720	Yes	2.925	2.102	0.823	Yes
20 min	0.098	0.659	-0.561	Yes Î	0.454	0.823	-0.369	Yes Î	0.971	1.059	-0.088	Yes Î	1.415	1.252	0.163	Yes	1.934	1.469	0.465	Yes	2.670	1.789	0.881	Yes	3.289	2.403	0.886	Yes
25 min	0.101	0.659	-0.558	Yes Î	0.475	0.821	-0.346	Yes	1.027	1.054	-0.027	Yesî	1.512	1.255	0.257	Yes	2.065	1.475	0.590	Yes	2.839	1.858	0.981	Yes	3.428	2.571	0.857	Yes
30 min	0.083	0.641	-0.558	Yes Î	0.483	0.789	-0.306	Yes Î	1.071	1.039	0.032	Yes	1.586	1.266	0.320	Yes	2.124	1.490	0.634	Yes	2.752	1.858	0.894	Yes	3.302	2.672	0.630	Yes
45 min	0.149	0.660	-0.511	Yes Î	0.561	0.811	-0.250	Yes Î	1.182	1.065	0.117	Yes	1.461	1.230	0.231	Yes	1.838	1.433	0.405	Yes	2.531	1.738	0.793	Yes	3.030	2.576	0.454	Yes
1 hour	0.167	0.584	-0.417	Yes ^	0.600	0.781	-0.181	Yes Î	0.994	1.010	-0.016	Yes Î	1.527	1.210	0.317	Yes	2.002	1.416	0.586	Yes	2.187	1.623	0.564	Yes	2.702	2.244	0.458	Yes
1.5 hou	0.108	0.535	-0.427	Yes Î	0.550	0.690	-0.140	Yes Î	0.832	0.914	-0.082	Yes Î	1.233	1.121	0.112	Yes	1.639	1.298	0.341	Yes	2.086	1.422	0.664	Yes	2.424	1.698	0.726	Yes
2 hour	0.222	0.546	-0.324	Yes Î	0.602	0.725	-0.123	Yes Î	0.887	0.909	-0.022	Yes ^	1.062	0.991	0.071	Yes	1.414	1.154	0.260	Yes	2.051	1.476	0.575	Yes	2.433	1.719	0.714	Yes
3 hour	0.153	0.459	-0.306	Yes ^	0.497	0.598	-0.101	Yes Î	0.774	0.733	0.041	Yes	1.006	0.919	0.087	Yes	1.266	1.073	0.193	Yes	1.491	1.251	0.240	Yes	1.723	1.400	0.323	Yes
4.5 hou	0.229	0.396	-0.167	Yes ^	0.455	0.548	-0.093	Yes Î	0.645	0.694	-0.049	Yes ^	0.720	0.745	-0.025	Yes ^	0.876	0.842	0.034	Yes	1.473	1.178	0.295	Yes	1.689	1.307	0.382	Yes
Max Q	0.229	0.660	-	-	0.602	0.823	-	-	1.182	1.065	-	-	1.586	1.266	-	-	2.124	1.490	-	-	2.839	1.858	-	-	3.428	2.672	-	-

DEVELOPMENT APPLICATION - NOT FOR CONSTRUCTION


ZHA	REV	DESCRIPTION	DATE	DRAWN	DESIGNED	CHECKED	APPRVD	SCALE	GF
1D00	C	AMENDMENTS TO ADDRESS MINOR LAYOUT CHANGE AND COUNCIL RFI	31/07/2020	RK	CG/AVG	SA	JF	0 20 40 60 80 100 120 140 160 180 200	M
OLAF	В	AMENDED AS PER UPDATED DESIGN	11/12/2019	RK	CG/AVG	JF	JF	A1 (A3) 1:2,000 (1:4,000) METRES	M
×.	Α	INITIAL RELEASE	20/11/2019	GM	CG/AVG	SA	JF		DI
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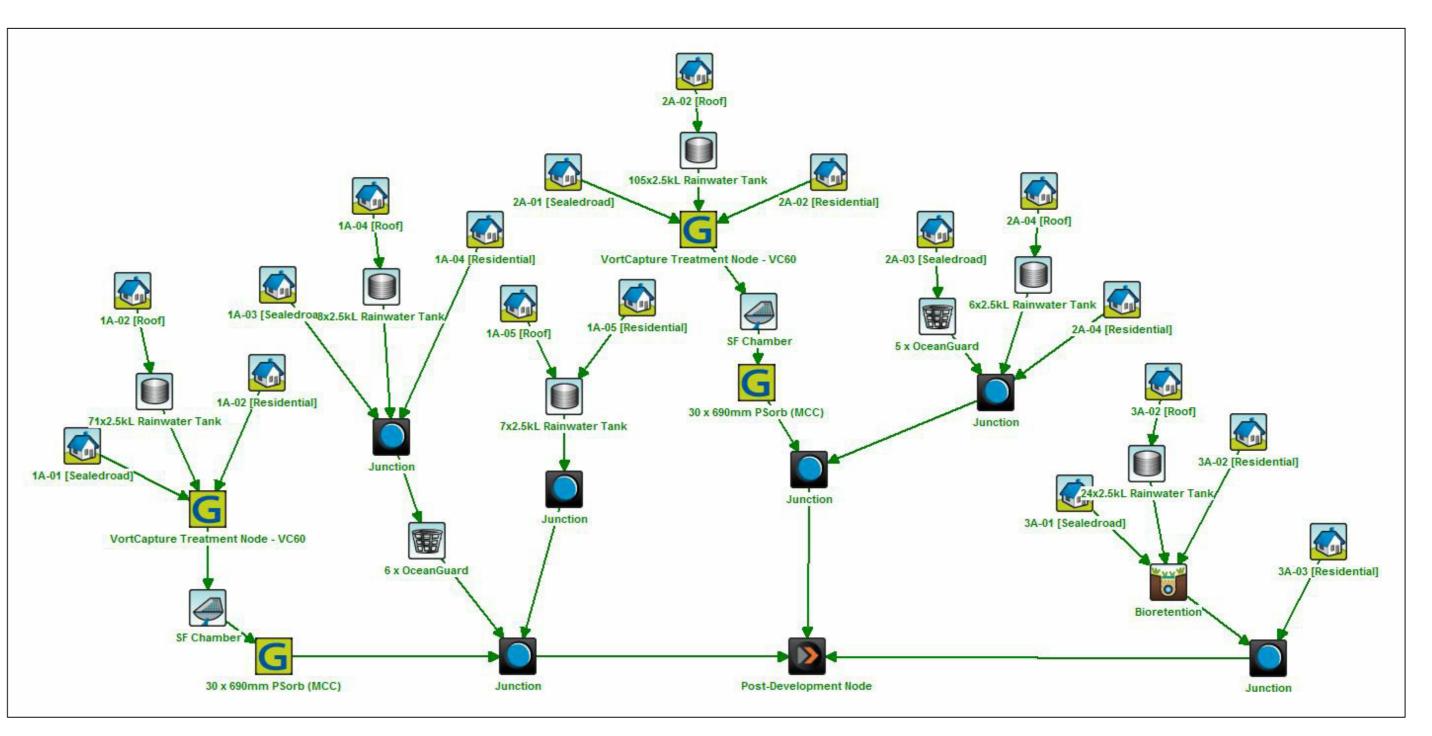
PROJECT MANAGER | CLIENT GRID DATUM COMMON GROUND PROPERTY P/L mAHD PROJECT NAME/PLANSET TITLE DISCLAIMER & COPYRIGHT This plan must not be used for construction unless signed as approved by principal certifying authority.

STRATFORD HOUSE LIFESTYLE VILLAGE All measurements in millimetres unless otherwise specified. PRELIMINARY ROADS DRAINAGE DESIGN This drawing must not be reproduced in whole or part without prior written consent of Martens & Associates Pty Ltd. STRATFORD HOUSE PRECINCT, TAHMOOR, NSW LOTS 1-7, 22, 23, 27-32, 35-37 DP 12096 & LOTS 2-3 DP236262 (C) Copyright Martens & Associates Pty Ltd



martens & Associates Pty Ltd	Consulting Engineers Environment Water Geotechnical	DRAWING TITLE OSD	CATCHMENT F	PLAN, MODEI	AND RESULTS	
	Civil	PROJECT NO.	PLANSET NO.	RELEASE NO.	DRAWING NO.	REVISION
Suite 201, 20 George St, Hornsby, NSW 2077 Australia Pt Email: mail@martens.com.au Internet		P1907155	PS04	R03	PS04-E600	С
		DRAWING ID: P1907155-PS04-R03-E	600	20 30 4	0 50 60 70	80 90 100



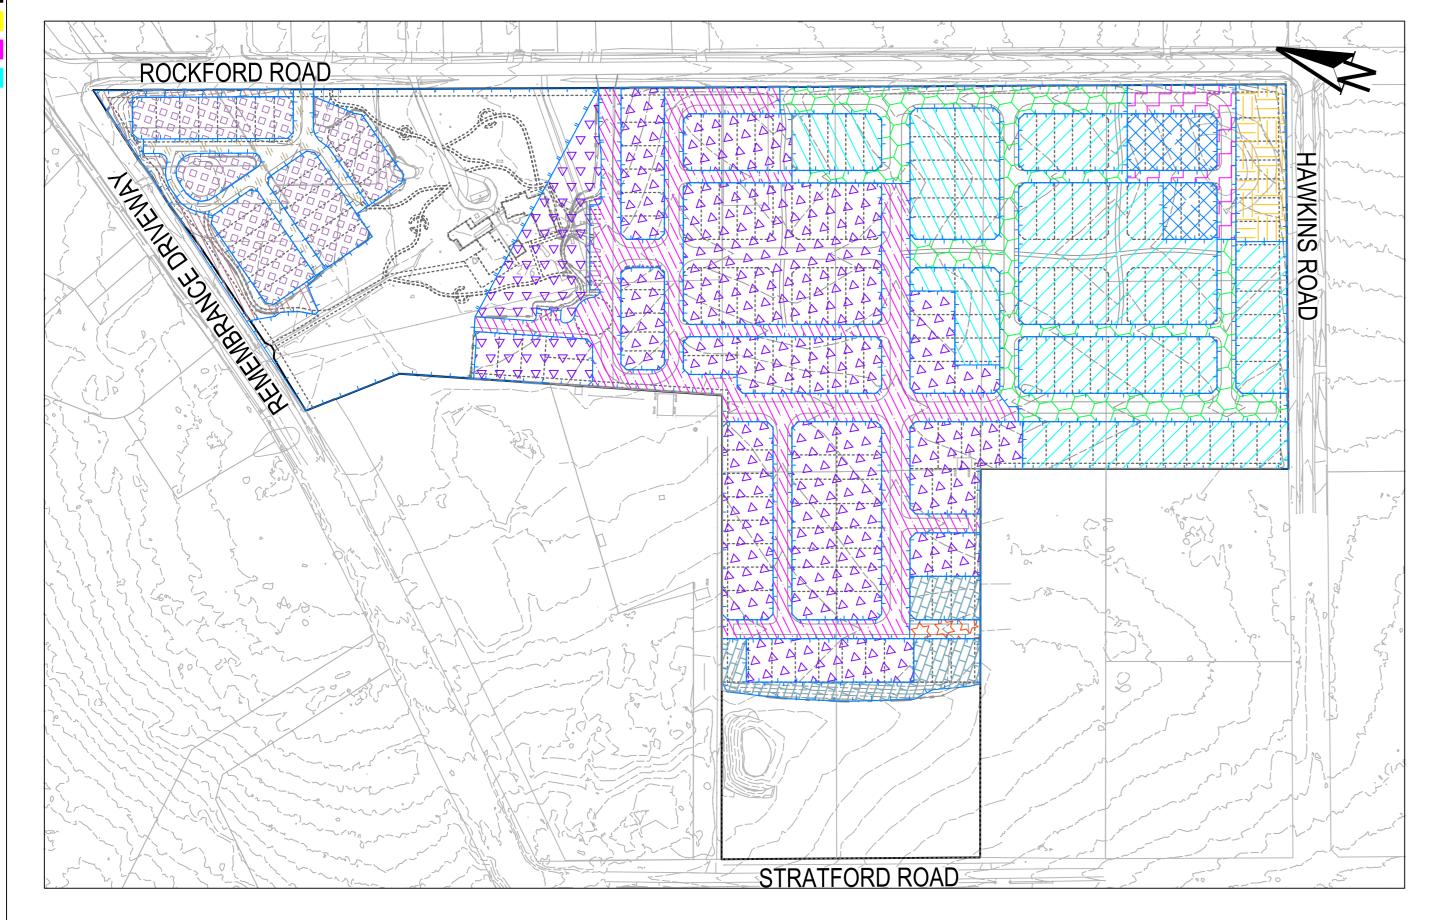

WATER QUALITY CATCHMENT PLAN

SCALE 1:2000

C MODEL DETAILS	5 (P19071551)	MUS01V02)
MUSIC NODE	AREA (ha)	% PAVED
1A-01SR	0.98	70%
1A-02RL	2.38	70%
1A-03SR	0.19	70%
1A-04RL	0.23	70%
1A-05RL	0.22	70%
2A-01SR	1.52	70%
2A-02RL	3.54	70%
2A-03SR	0.04	70%
2A-04RL	0.30	70%
3A-01SR	0.24	70%
3A-02RL	0.74	70%
3A-03RL	0.21	20%
	10.57	= 100% OF TOTAL AREA
S AREA	7.29	= %69 OF TOTAL AREA
AREA	3.28	= %31 OF TOTAL AREA
	MUSIC NODE 1A-01SR 1A-02RL 1A-03SR 1A-04RL 1A-05RL 2A-01SR 2A-02RL 2A-03SR 2A-04RL 3A-01SR 3A-01SR 3A-01SR	MUSIC NODE 1A-01SR 0.98 1A-02RL 1A-03SR 0.19 1A-04RL 0.23 1A-05RL 0.22 2A-01SR 1.52 2A-02RL 2A-03SR 0.04 2A-04RL 0.30 3A-01SR 0.24 3A-02RL 0.74 3A-03RL 0.21 10.57 S AREA

	Sources	Residual Load	% Reduction
Flow (ML/yr)	42.7	37.1	13
Total Suspended Solids (kg/yr)	6190	1080	82.6
Total Phosphorus (kg/yr)	12.7	4.35	65.7
Total Nitrogen (kg/yr)	96	50.7	47.2
Gross Pollutants (kg/yr)	1480	26.1	98.2

MUSIC MODEL RESULT

DEVELOPMENT APPLICATION - NOT FOR CONSTRUCTION

∄ REV	DESCRIPTION	DATE	DRAWN	DESIGNED	CHECKED	APPRVD	SCALE						GRID	DATUM	PROJECT MANAGER	CLIENT
<u>و</u> ر	AMENDMENTS TO ADDRESS MINOR LAYOUT CHANGE AND COUNCIL RFI	31/07/2020	RK	CG/AVG	SA	JF	0 20	40 60	80 100	120 140	160	180 200	MGA	mAHD		COMMON GROUND PROPERTY P/L
∀ H J B	AMENDED AS PER UPDATED DESIGN	11/12/2019	RK	CG/AVG	JF	JF	A1 (A3) 1:	2,000 (1:4,000))			METRES	MUA	IIIAND) JF	COMMON GROUND FROI LIVEFF
¥ A	INITIAL RELEASE	20/11/2019	GM	CG/AVG	SA	JF							DISCLAIMER	& COPYRIGHT		PROJECT NAME/PLANSET TITLE
USEF													This plan must not be used for construction unless signed as approved by principal certifying authority.		ion unless signed as approved by	STRATFORD HOUSE LIFESTYLE VILLAGE
!													All measurements	in millimetres unless	otherwise specified.	
															whole or part without prior written	PRELIMINARY ROADS DRAINAGE DESIGN
N LEC													1	s & Associates Pty Ltd		STRATFORD HOUSE PRECINCT, TAHMOOR, NSW
PR													(C) Copyright N	Martens & Associa	ates Pty Ltd	LOTS 1-7, 22, 23, 27-32, 35-37 DP 12096 & LOTS 2-3 DP236262
A1 / A3	LANDSCAPE (A1LC_v02.0.01)															

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Environment
Water
Geotechnical
Civil

WATER QUALITY MODEL LAYOUT

PROJECT NO. PLANSET NO. RELEASE NO. DRAWING NO. REVISION

Suite 201, 20 George St, Hornsby, NSW 2077 Australia Phone: (02) 9476 9999 Fax: (02) 9476 8767 P1907155

Email: mail@martens.com.au Internet: www.martens.com.au

Email: mail@martens.com.au Internet: www.martens.com.au

Example PROJECT NO. PLANSET NO. RELEASE NO. PS04—R03

PROJECT NO. PLANSET NO. RELEASE NO. PS04—R03


PS04—E700


DRAWING NO. REVISION

DRAWING NO. PS04—E700

DRAWING ID: P1907155-PS04-R03-E700

DRAWING ID: P19

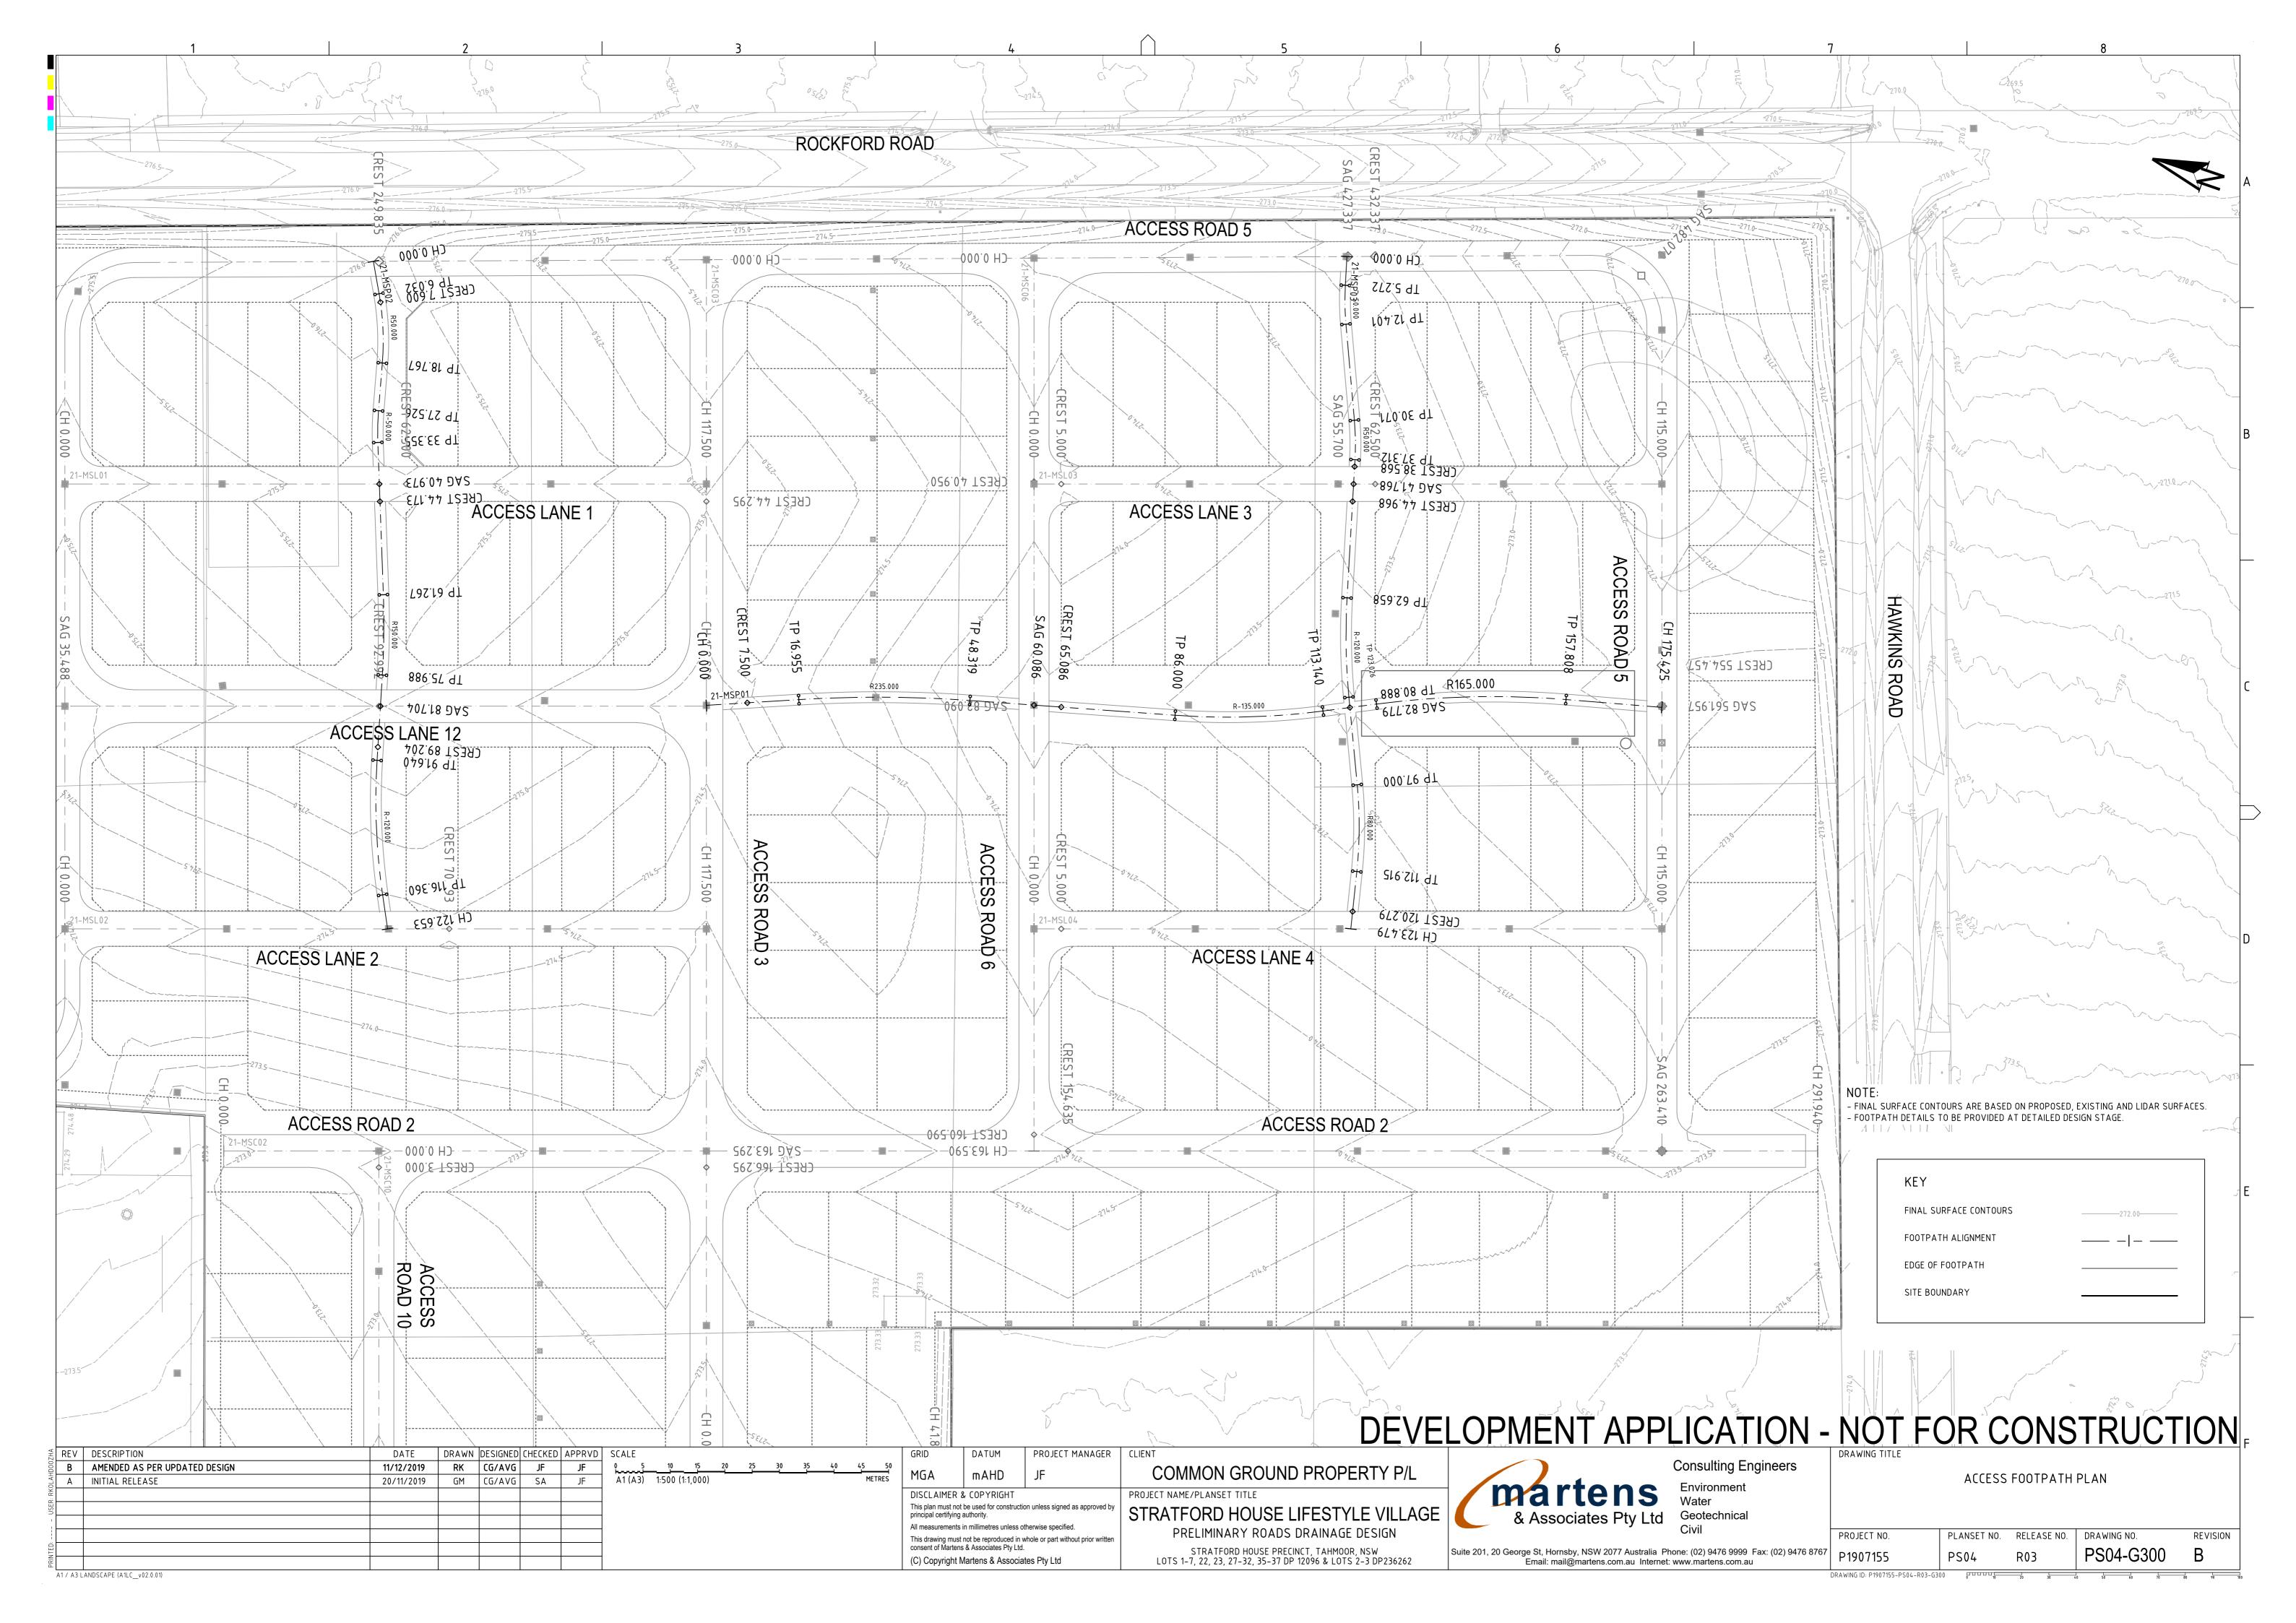

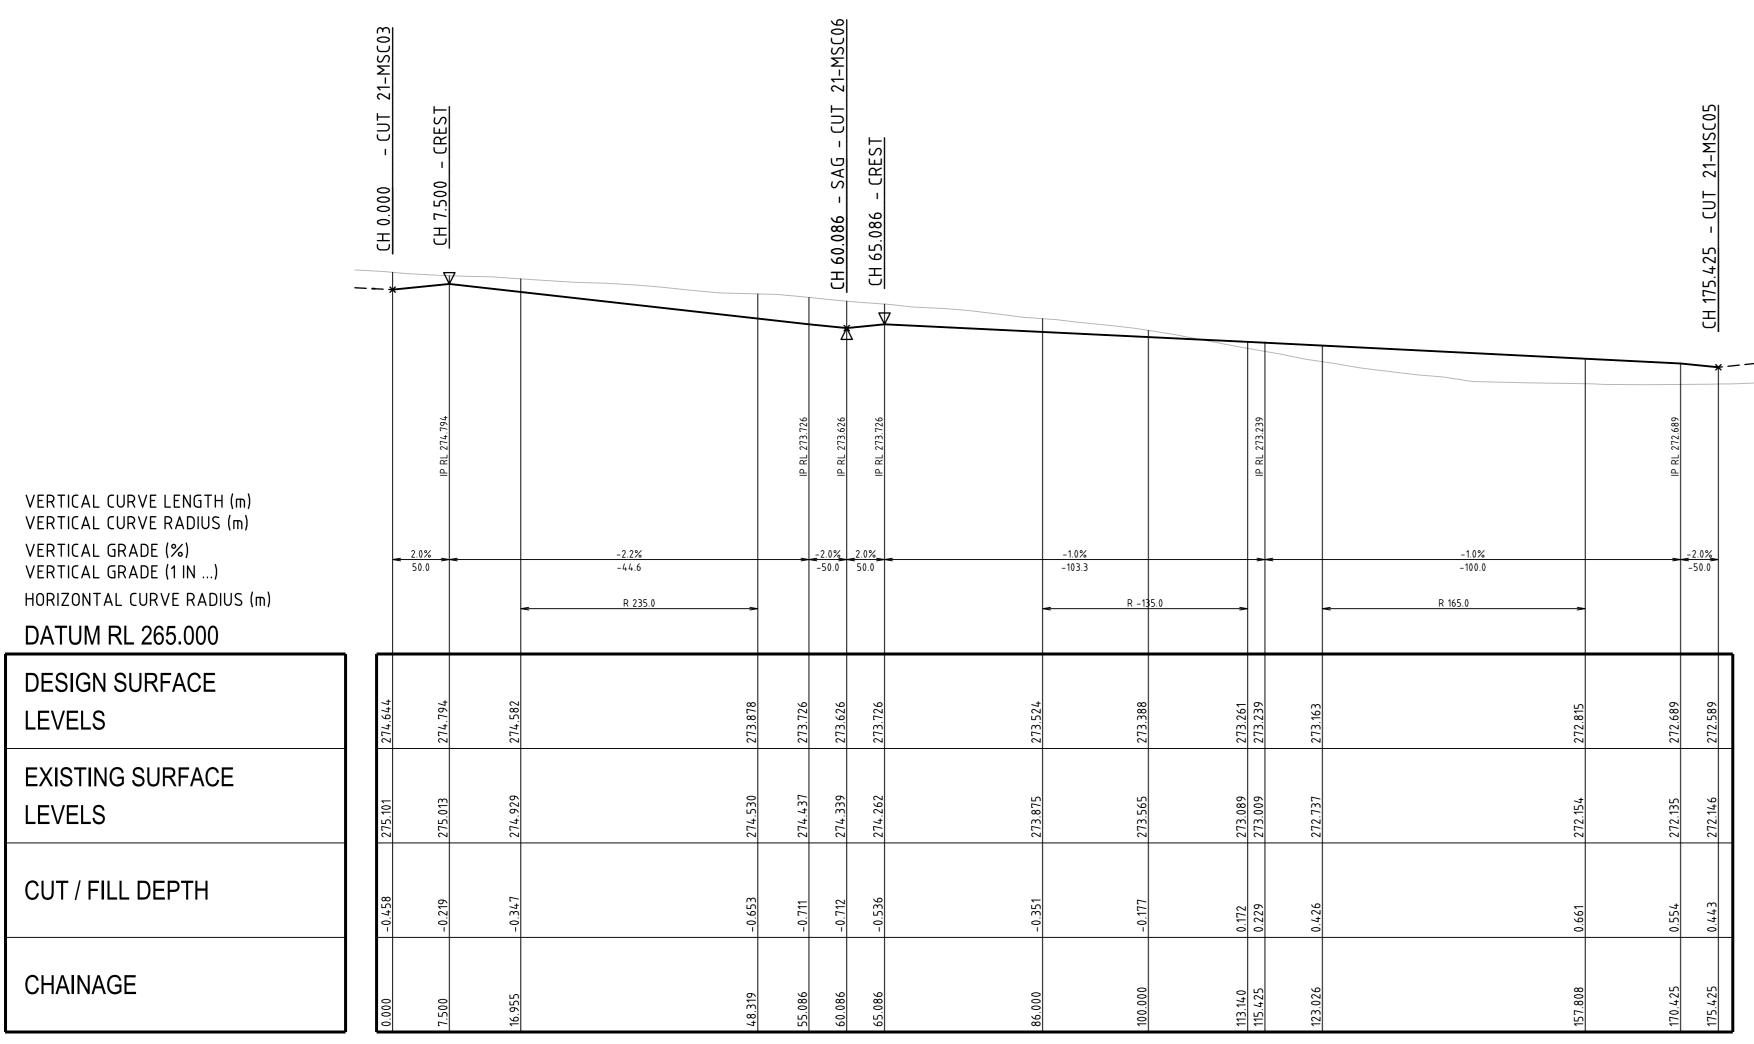

ACCESS FOOTPATH 1 (21-MSP01) LONG. SECTION

VERTICAL - 1:100

SCALE: HORIZONTAL - 1:500

ZHA	REV	DESCRIPTION	DATE	DRAWN	DESIGNED	CHECKED	APPRVD	SCALE	GRID	DATUM	PROJECT MANAGER	CLIENT
000	В	AMENDED AS PER UPDATED DESIGN	11/12/2019	RK	CG/AVG	JF	JF	0 5 10 15 20 25 30 35 40 45 50	MGA	mAHD	15	COMMON GROUND PROPERTY P/L
OLAH	Α	INITIAL RELEASE	20/11/2019	GM	CG/AVG	SA	JF	A1 (A3) 1:500 (1:1,000) METRES	MUA	IIIAND) JF	COMMON ONCOME I NOI LIVI I /L
 X								0 1 2 3 4 5 6 7 8 9 10	1	ER & COPYRIGHT		PROJECT NAME/PLANSET TITLE
USEF								A1 (A3) 1:100 (1:200) METRES		This plan must not be used for construction unless signed as approved by principal certifying authority.		STRATFORD HOUSE LIFESTYLE VILLAGE
1									1 ' '			STIVATI OND HOUSE LII ESTTEE VIELAGE
- 11					+	-			All measurem	ents in millimetres unless of	therwise specified.	PRELIMINARY ROADS DRAINAGE DESIGN
- 1					1 1				This drawing	must not be reproduced in	whole or part without prior written	FRELIMINARY ROADS DRAINAGE DESIGN
TED:										artens & Associates Pty Ltd		STRATFORD HOUSE PRECINCT, TAHMOOR, NSW
PRIN									(C) Copyric	ght Martens & Associa	ites Pty Ltd	LOTS 1-7, 22, 23, 27-32, 35-37 DP 12096 & LOTS 2-3 DP236262
4	1/ A3	ANDSCAPE (A1LC_v02.0.01)			'	'		•	-			



Consulting Engineers Environment Water Geotechnical Civil

Suite 201, 20 George St, Hornsby, NSW 2077 Australia Phone: (02) 9476 9999 Fax: (02) 9476 8767 Email: mail@martens.com.au Internet: www.martens.com.au

			CINO						
	DRAWING TITLE								
	ACCESS FOC	ACCESS FOOTPATH 1 (21-MSP01) LONGITUDINAL SI							
	PROJECT NO.	PLANSET NO.	RELEASE NO.	DRAWING NO.	REVISION				
7	P1907155	PS04	R03	PS04-G310	В				

VERTICAL CURVE LENGTH (m) VERTICAL CURVE RADIUS (m) VERTICAL GRADE (%) VERTICAL GRADE (1 IN ...) HORIZONTAL CURVE RADIUS (m) R 150.0 DATUM RL 267.000 **DESIGN SURFACE** 275.407 275.372 276.129 276.160 **LEVELS EXISTING SURFACE LEVELS** CUT / FILL DEPTH CHAINAGE ACCESS FOOTPATH 2 (21-MSP02) LONG. SECTION

> SCALE: HORIZONTAL - 1:500 VERTICAL - 1:100

VERTICAL CURVE LENGTH (m) VERTICAL CURVE RADIUS (m) HORIZONTAL CURVE RADIUS (m) R -50.0 R -120.0 R 80.0 R 50.0 272.606 272.606 272.605 272.605 273.021 273.019 0.233 1.023 1.038 0.974 1.038 37.312 38.568 41.768 44.968

ACCESS FOOTPATH 3 (21-MSP03) LONG. SECTION

SCALE: HORIZONTAL - 1:500 VERTICAL - 1:100

DEVELOPMENT APPLICATION - NOT FOR CONSTRUCTION -

ZHA	REV	DESCRIPTION	DATE	DRAWN	DESIGNED	CHECKED	APPRVD	SCALE	GRID	DATUM	PROJECT MANAGER	CLIENT
1D00	В	AMENDED AS PER UPDATED DESIGN	11/12/2019	RK	CG/AVG	JF	JF	0 5 10 15 20 25 30 35 40 45 50	MGA	mAHD	IE	COMMON GROUND PROPERTY P/L
OLAH	Α	INITIAL RELEASE	20/11/2019	GM	CG/AVG	SA	JF	A1 (A3) 1:500 (1:1,000) METRES	MUA	IIIAND	JF	COMMON ONCOME IN THE
?: RK								0 1 2 3 4 5 6 7 8 9 10	1	& COPYRIGHT		PROJECT NAME/PLANSET TITLE
USEF								A1 (A3) 1:100 (1:200) METRES	This plan must no principal certifying		ion unless signed as approved by	STRATFORD HOUSE LIFESTYLE VILLAGE
1									1 , ,	s in millimetres unless o		
									1		whole or part without prior written	PRELIMINARY ROADS DRAINAGE DESIGN
TED:										ns & Associates Pty Ltd		STRATFORD HOUSE PRECINCT, TAHMOOR, NSW
PRIN									(C) Copyright	Martens & Associa	ates Pty Ltd	LOTS 1-7, 22, 23, 27-32, 35-37 DP 12096 & LOTS 2-3 DP236262
	A1 / A3 LANDSCAPE (A1LC_v02.0.01)											

martens & Associates Pty Ltd

VERTICAL GRADE (%)

VERTICAL GRADE (1 IN ...)

DATUM RL 265.000

DESIGN SURFACE

EXISTING SURFACE

CUT / FILL DEPTH

LEVELS

LEVELS

CHAINAGE

Consulting Engineers

ACCESS FOOTPATH 2 (21-MSP02) & 3 (21-MSP03) LONG. SECTIONS

PROJECT NO. PLANSET NO. RELEASE NO. DRAWING NO. REVISION PS04-G311 Suite 201, 20 George St, Hornsby, NSW 2077 Australia Phone: (02) 9476 9999 Fax: (02) 9476 8767 Email: mail@martens.com.au Internet: www.martens.com.au